


#### EXHIBIT 2

PROJECT PLANS

# KENDALL REDI WASTEWATER (CONTRACT 1)

TOWN OF KENDALL / TOWN OF HAMLIN, NY

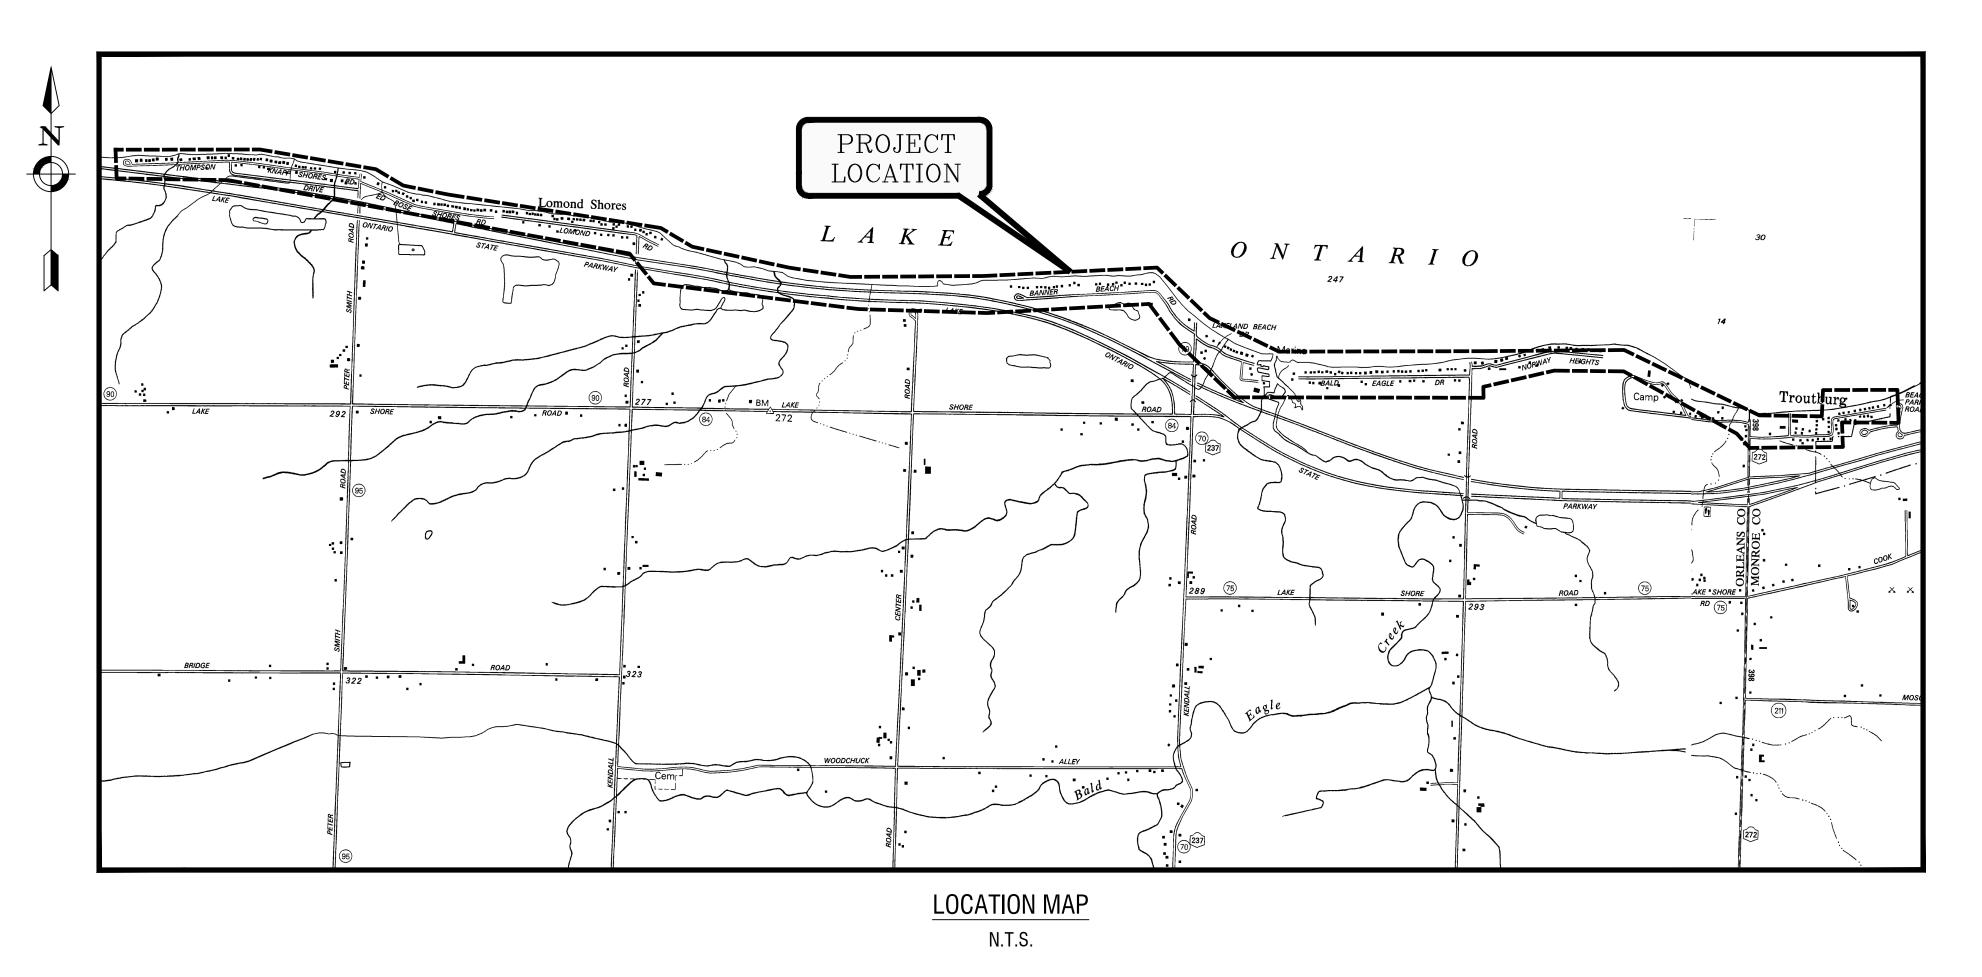

#### DRAWING INDEX

G001 SHEET IN

C001 GENERAL NOTES AND LEGE

C301 - 337 LOW PRESSURE SEWER PLAN & PROFIL

C401 PUMP STATION 01 PLAN

C402 PUMP STATION 01 DETAILS

C501 - 503 CONSTRUCTION DETAILS

C504 MPOT PLAN

C505 MPOT DETAILS

06 MPOT NOTES


# TOWN OF KENDALL


1873 KENDALL RD, KENDALL, NY 14476
PROJECT NO: 2200455
SEPTEMBER 2023



300 State Street, Suite 201 Rochester, NY 14614 585-454-6110

labellapc.com

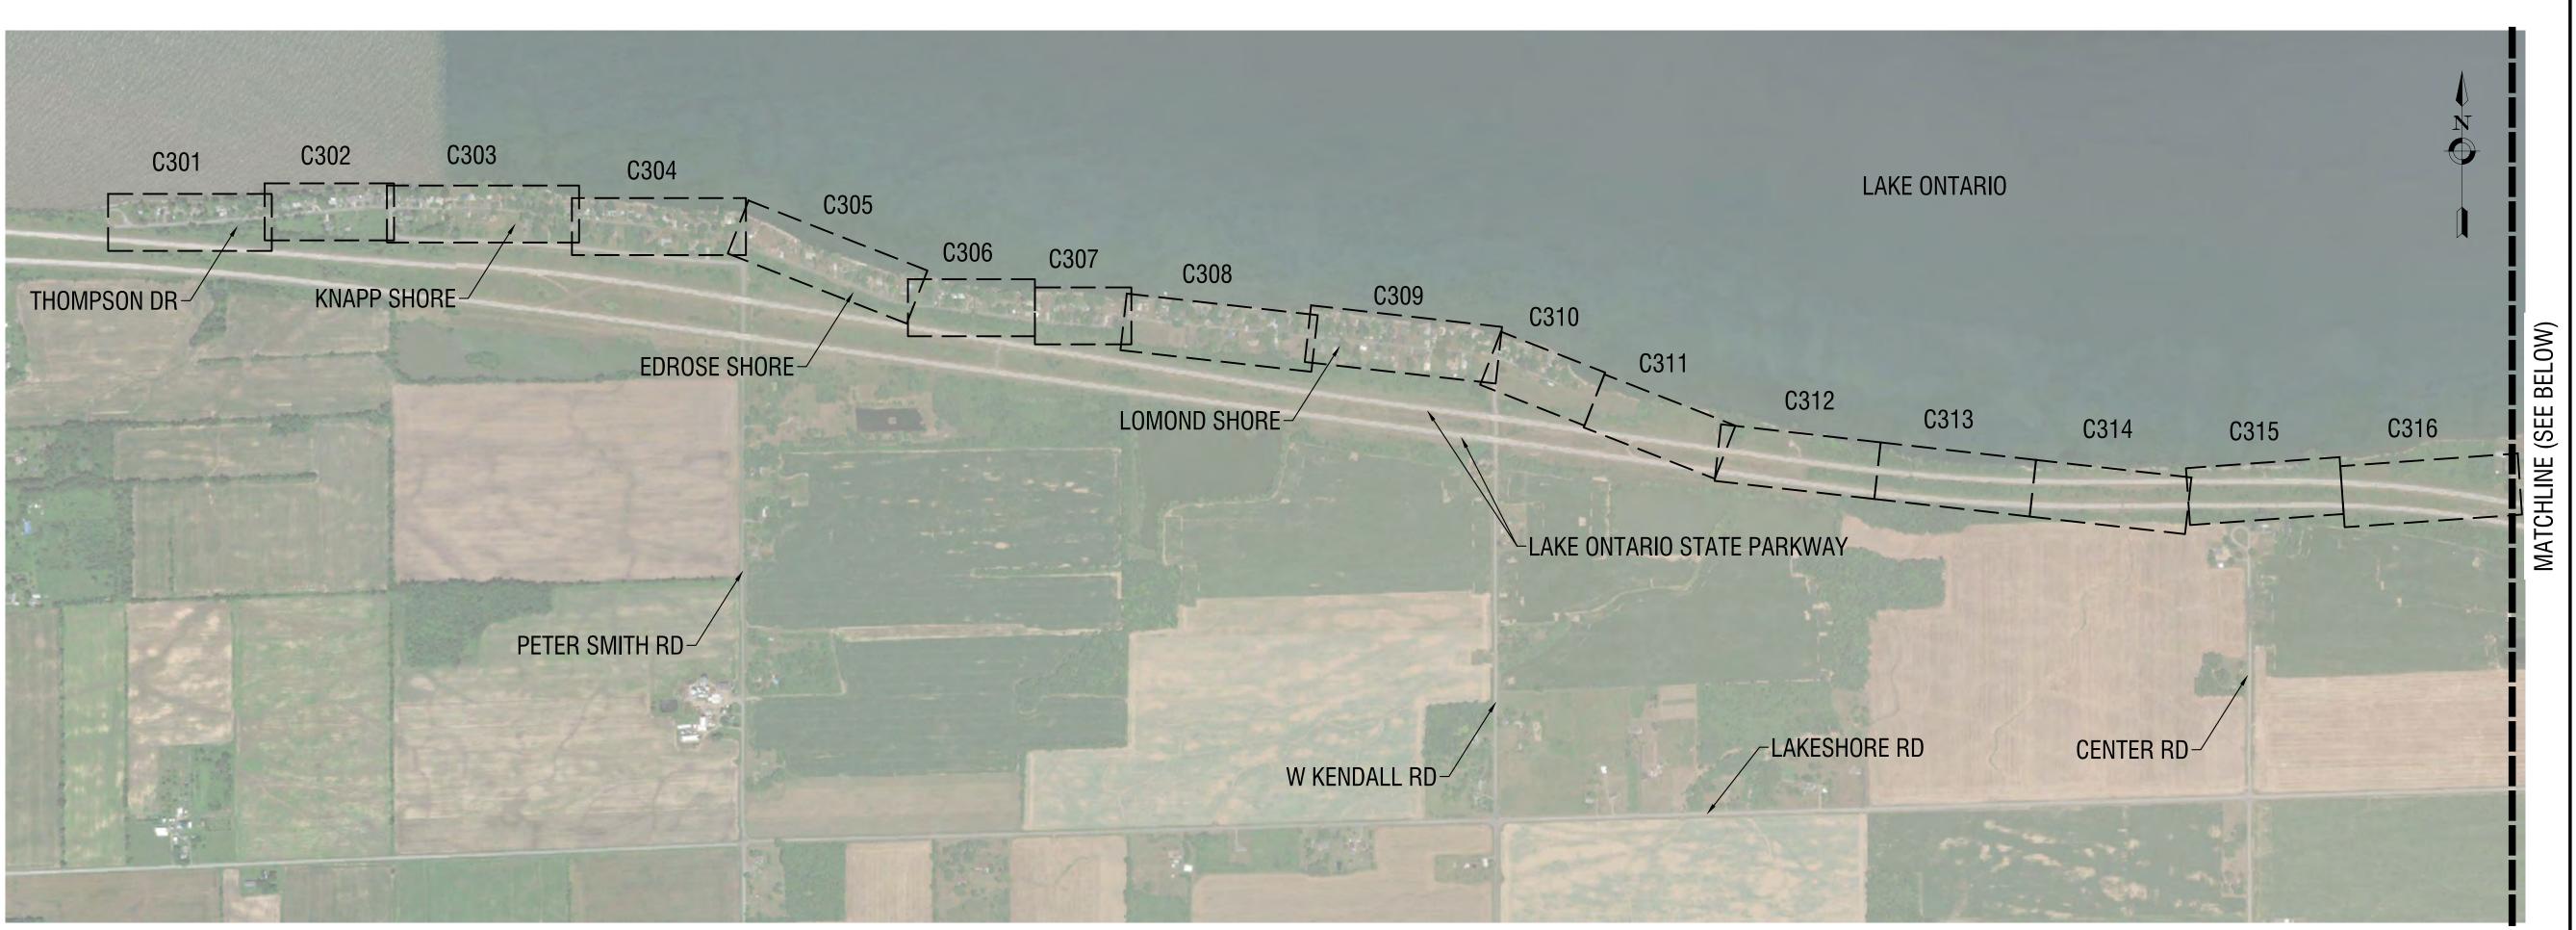


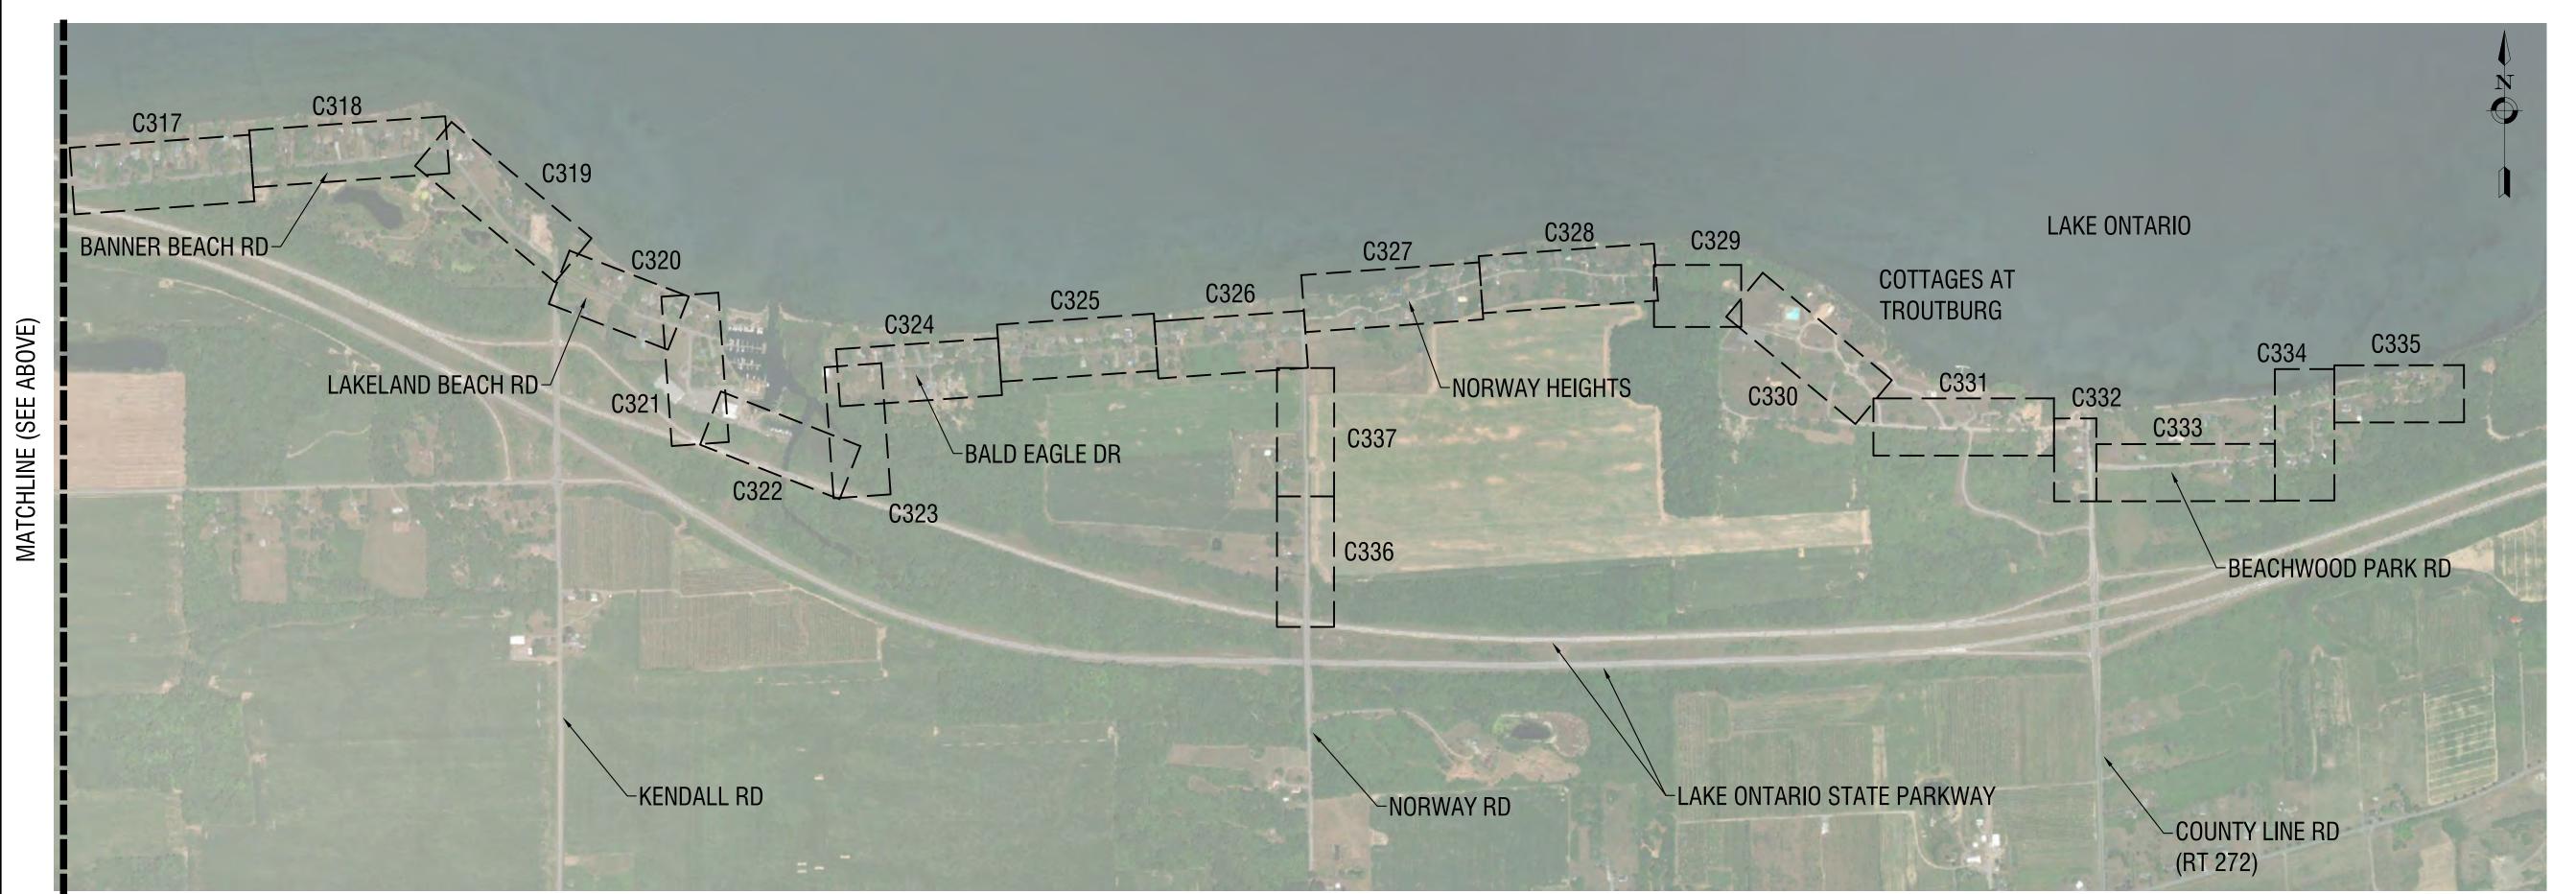

LaBella
Powered by partnership.

300 State Street, Suite 201 Rochester, NY 14614 585-454-6110


labellapc.com

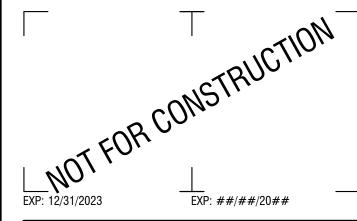

CERTIFICATE OF AUTHORIZATION NUMBER: PROFESSIONAL ENGINEERING: 095099 LAND SURVEYING: 017976 GEOLOGICAL: 018750

It is a violation of New York Education Law Art. 145 Sec. 7209 & Art. 147 Sec. 7307, for any person, unless acting under the direction of a licensed architect, professional engineer, or land surveyor, to alter an item in any way. If an item bearing the seal of an architect, engineer, or land surveyor is altered; the altering architect, engineer, or land surveyor shall affix to the item their seal and notation "altered by" followed by their signature and date of such alteration, and a specific description of the alteration.

© 2023 LaBella Associates

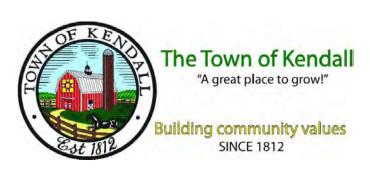

#### REDI WASTEWATER INFRASTRUCTURE (CONTRACT 1)

TOWN OF KENDALL & TOWN OF HAMLIN

PROJECT NUMBI	ER: 2200455	
DRAWN BY:		
REVIEWED BY:	JCP	
NEVIEWED DT.	JRE	
ISSUED FOR:	60% DESIGN SUBMISSION	
DATE:	SEPTEMBER 2023	

DESCRIPTION:

NO: DATE:

SHEET INDEX

DRAWING NUMBER:

G001

ash.lab∖p\PAM7\Kendall, Town of∖2200455 - REDI Wastewater Infrastructure\Drawings∖Civil∖01 CONTRACT NO 1. (LPSM COLLECTION)∖KEY SHEETS.dwg ti /ɔnɔ੨ ३⋅ҕ1⋅ɔァ pм

- 2. THE HORIZONTAL AND VERTICAL LOCATION OF ALL EXISTING ABOVE GROUND AND BELOW GROUND UTILITIES, STRUCTURES, AND APPURTENANCES SHOWN ON THE PLANS ARE APPROXIMATE AND ARE NOT GUARANTEED. THE CONTRACTOR ALONE IS RESPONSIBLE FOR DETERMINING THE EXACT HORIZONTAL AND VERTICAL LOCATION OF ALL UTILITIES, STRUCTURES, AND APPURTENANCES IN THE PATH OF AND ADJACENT TO THE PROPOSED WORK AND REPORT THE RESULTS TO THE ENGINEER.
- 3. PRIOR TO THE START OF CONSTRUCTION, DIG TEST PITS TO DETERMINE PRECISE LOCATIONS AND DEPTH OF ANY UNDERGROUND UTILITY IN QUESTION AND IMPACTED BY THE WORK. IMMEDIATELY REPORT RESULTS TO THE ARCHITECT/ENGINEER OF ANY SIGNIFICANT DISCREPANCIES BETWEEN THE PLANS AND ACTUAL LOCATIONS OF SAID STRUCTURES. TEST PITS AND ASSOCIATED REPORTING WILL BE AT NO ADDITIONAL COST TO THE OWNER.
- 4. PROPERTY LINES AND RIGHTS-OF-WAY LINES AS SHOWN ARE APPROXIMATE AND ARE INTENDED FOR GENERAL INFORMATION. NO WARRANTY IS EXPRESSED OR IMPLIED TO
- 5. NOTIFY THE "DIG SAFELY NEW YORK" UNDERGOUND FACILITIES PROTECTION ORGANIZATION 2 FULL WORKING DAYS NOT INCLUDING THE DAY OF YOUR CALL, WEEKENDS OR HOLIDAYS BEFORE COMMENCING EXCAVATION OR DRILLING OPERATIONS, AT 811 FOR A UTILITY STAKEOUT.
- 6. THE SIZES AND MATERIAL OF CONSTRUCTION OF WATER MAINS AND SEWERS TO REMAIN ARE REPUTED. VERIFY SIZES OF ALL UTILITIES WHERE CONNECTIONS TO EXISTING UTILITIES ARE REQUIRED. EXCAVATION TO VERIFY THESE UTILITIES WILL BE MADE AT NO ADDITIONAL COST TO THE OWNER.
- 7. PRESERVE AND SUPPORT ALL EXISTING PIPELINES, CONDUITS, AND CULVERTS ENCOUNTERED DURING EXCAVATION.
- 8. MAINTAIN SAFE AND CONTINUOUS ACCESS TO ALL ACTIVE FIRE HYDRANTS THROUGHOUT THE PERIOD OF CONSTRUCTION UNLESS OTHERWISE NOTED ON THE PLANS.
- 9. MAINTAIN DRAINAGE WITHIN THE PROJECT AREA THROUGHOUT THE CONSTRUCTION PERIOD
- 10. PRESERVE AND PROTECT FROM DAMAGE ALL SIGNS, SURVEY MONUMENTS, MAIL BOXES, LIGHT POLES AND OTHER STREET APPURTENANCES WITHIN THE RIGHT-OF-WAY AND WITHIN EASEMENTS EXISTING OR OBTAINED FOR THE PROJECT.
- 11. PRESERVE AND PROTECT FROM DAMAGE ALL TREES, SHRUBS, AND PLANTS IN THE VICINITY OF THE PROPOSED WORK THAT ARE NOT OTHERWISE DESIGNATED FOR REMOVAL UNDER THIS CONTRACT.
- 12. REPAIR, OR REPLACE IN-KIND, AS DETERMINED BY THE ENGINEER AND AT NO ADDITIONAL COST TO THE OWNER, ANY UTILITY, STREET APPURTENANCE, OR OTHER ITEM WHICH BECOMES DAMAGED AS A RESULT OF THE CONTRACTOR'S OPERATIONS.
- 13. PROTECT AND PRESERVE ALL RIGHT-OF-WAY MONUMENTS AND PROPERTY CORNERS TO REMAIN. REPLACE, UNDER THE DIRECTION OF A LICENSED SURVEYOR AND AT NO ADDITIONAL COST TO THE OWNER, ALL RIGHT-OF-WAY MONUMENTS AND PROPERTY CORNERS DISTURBED BY THE CONTRACTOR'S OPERATIONS.
- 14. PROMPTLY REMOVE AND PROPERLY DISPOSE OF ALL MATERIALS NOT OTHERWISE DESIGNATED TO BE STORED, REUSED, RELOCATED OR TURNED OVER TO THE OWNER OFFSITE. ALL DISPOSALS SHALL BE IN ACCORDANCE WITH FEDERAL, STATE AND LOCAL REGULATIONS. OBTAIN ANY AND ALL PERMITS REQUIRED FOR THE DISPOSAL.
- 15. DEWATER ALL EXCAVATIONS TO PREVENT THE INTRODUCTION OF GROUNDWATER INTO THE TRENCHES/EXCAVATIONS. PROVIDE ALL EQUIPMENT NECESSARY TO MAINTAIN THE GROUNDWATER LEVEL AS NECESSARY.
- 16. ADJUST THE RIMS OF ALL MANHOLES, CATCH BASINS, VALVE BOXES AND OTHER UTILITY SITE STRUCTURES TO MEET FINISHED GRADE IN AREAS REQUIRING REPAVING OR REGRADING AS PART OF THE WORK, INCLUDING THOSE THAT MAY NOT BE SHOWN ON THE PLANS.
- 17. THERE MAY BE OTHER CONTRACTS FOR WORK TO BE DONE IN AND/OR ADJACENT TO WORK AREAS OF THIS CONTRACT DURING THE WORK PERIOD OF THIS CONTRACT. THIS CONTRACTOR AND SUCH OTHER CONTRACTORS SHALL COORDINATE THEIR WORK TO CONFORM TO THE PROGRESSIVE OPERATION OF ALL THE WORK COVERED BY SUCH CONTRACTS, AND AFFORD EACH OTHER REASONABLE OPPORTUNITIES FOR THE INTRODUCTION AND STORAGE OF THEIR SUPPLIES, MATERIALS, EQUIPMENT AND THE

#### SURVEY NOTES

- FIELD VERIFY ALL EXISTING CONDITIONS PRIOR TO BID. NO ALLOWANCE WILL BE MADE
  FOR ADDITIONAL COSTS DUE TO CONTRACTOR'S FAILURE TO VERIFY EXISTING
  CONDITIONS
- 2. LOCATE, MARK, SAFEGUARD AND PRESERVE ALL SURVEY MARKERS AND RIGHT-OF-WAY MARKERS IN THE AREA OF CONSTRUCTION.
- 3. ANY IRON PINS, MONUMENTS OR OTHER ITEMS DEFINING PROPERTY LINES WHICH ARE DISTURBED BY CONSTRUCTION OPERATIONS SHALL BE PROPERLY TIED AND ACCURATELY RESET BY A NYS LICENSED SURVEYOR UPON COMPLETION OF THE WORK.
- 4. HORIZONTAL DATUM BASED OFF NAD83 (2011) (GRID).
- 5. VERTICAL BASED OFF OF NAVD88.

EXECUTION OF THEIR WORK.

#### SITE NOTES

- 1. WELL COMPACTED SUBGRADE SHALL BE UTILIZED UNDERNEATH CONSTRUCTION OF PAVEMENT AND CONCRETE BASES.
- ALL STAKEOUT FOR THE PROPOSED SITE IMPROVEMENTS SHALL BE COMPLETED BY A NEW YORK STATE LICENSED LAND SURVEYOR.
- 3. IF ANY DISCREPANCIES ARE NOTED BETWEEN THESE CONSTRUCTION DOCUMENTS AND INFORMATION PROVIDED OR AN ERROR IS SUSPECT, IT SHALL BE IMMEDIATELY REPORTED TO THE CONSTRUCTION MANAGER AND LABELLA ASSOCIATES PROJECT MANAGER IN WRITING.
- 4. PARCEL LINES AS SHOWN BY ORLEANS COUNTY GIS DATABASE, FOR THE TOWN OF KENDALL.

#### DEMOLITION AND REMOVAL NOTES

- 1. THE CONTRACTOR IS RESPONSIBLE FOR PROMPT REMOVAL AND PROPER DISPOSAL OFF-SITE OF ALL MATERIALS NOT OTHERWISE DESIGNATED TO BE STORED, REUSED, RELOCATED OR TURNED OVER TO THE OWNER.
- 2. ALL EXCAVATED MATERIAL, TO BE REMOVED FROM THE SITE AND PROPERLY DISPOSED OF BY THE CONTRACTOR.
- 3. ALL DISPOSALS SHALL BE IN ACCORDANCE WITH FEDERAL, STATE AND LOCAL REGULATIONS. THE CONTRACTOR IS RESPONSIBLE FOR OBTAINING ANY AND ALL PERMITS REQUIRED AND THE COST OF DISPOSAL. PROVIDE DOCUMENTATION OF DISPOSAL.
- 4. ALL ASPHALT AND CONCRETE TO BE SAWCUT WITH A STRAIGHT AND NEAT EDGE PRIOR TO EXCAVATION. ANY ASPHALT OR CONCRETE DESIGNATED TO REMAIN AND DAMAGED DURING CONSTRUCTION SHALL BE REPLACED IN-KIND BY THE CONTRACTOR AT NO ADDITIONAL COST TO THE OWNER.
- 5. COMPLETE ALL DEMOLITIONS AND REMOVALS AS REQUIRED TO COMPLETE THE WORK
- 6. PROVIDE A DUMPING PERMIT SIGNED BY THE OWNER OF ANY PROPERTY WHERE MATERIAL WILL BE DISPOSED OF. THE PERMIT MUST INCLUDE THE OWNER NAME AND PROPERTY ADDRESS AND RELEASE THE OWNER AND ENGINEER OF ANY CLAIMS PRESENT AND FUTURE FOR DAMAGE TO THE PROPERTY. PERMITS MUST BE RECEIVED BY THE ENGINEER PRIOR TO THE START OF CONSTRUCTION.
- 7. SITE DRAINAGE, INCLUDING THE PROJECT SITE AND ADJACENT PRIVATE AND PUBLIC ROADWAYS, DRIVES, PARKING AREAS OR PROPERTIES SHALL BE MAINTAINED THROUGHOUT THE CONSTRUCTION PERIOD.
- 8. NOTIFY THE LOCAL GOVERNMENT, LOCAL FIRE DEPARTMENT AND THE NEW YORK STATE DEPARTMENT OF ENVIRONMENTAL CONSERVATION (NYSDEC) AS NECESSARY TO OBTAIN ANY REQUIRED PERMITS PRIOR TO BEGINNING WORK. COPIES OF ANY REQUIRED PERMITS SHALL BE PROVIDED TO THE OWNER PRIOR TO BEGINNING THE WORK.
- 9. REMOVE FROM SITE, MATERIALS NOT INDICATED TO BE SALVAGED INCLUDING ALL DEBRIS. ALL REMOVED MATERIALS SHALL BECOME THE PROPERTY OF CONTRACTOR WHO SHALL LEGALLY DISPOSE OF SAME.
- 10. ALL TREES, SHRUBS AND PLANTS DESIGNATED TO REMAIN AND DISTURBED BY CONSTRUCTION OPERATIONS, SHALL BE REPLACED IN-KIND AS DIRECTED BY THE ARCHITECT/ENGINEER AND/OR OWNER'S DESIGNATED REPRESENTATIVE AT NO ADDITIONAL COST TO THE OWNER.
- 11. MAINTAIN SAFE VEHICULAR AND PEDESTRIAN ACCESS TO THE EXISTING BUILDINGS FOR THE DURATION OF THE CONTRACT.
- 12. WHEN EXISTING CONSTRUCTION WHICH IS TO REMAIN IS DAMAGED DURING THE COURSE OF CONSTRUCTION AS A RESULT OF CONTRACTORS WORK, IT SHALL BE REPAIRED AND/OR REPLACED WITH SIMILAR OR LIKE MATERIALS AS MUCH AS POSSIBLE, AT NO COST TO THE OWNER. ALL REPAIRS AND/OR REPLACEMENTS WILL BE SUBJECT TO OWNERS APPROVAL.
- 13. COORDINATE LOCATION OF TEMPORARY CONSTRUCTION FENCE AND TEMPORARY STONE STAGING AREA WITH OWNER

#### **EXCAVATION AND GRADING NOTES**

- 1. CONFORM TO THE REQUIREMENTS OF OSHA, AND ANY OTHER AGENCY HAVING JURISDICTION WITH REGARD TO SAFETY PRECAUTIONS WITH TRENCHING OPERATIONS. THE REQUIREMENTS SET FORTH HEREIN ARE INTENDED TO SUPPLEMENT REQUIREMENTS ESTABLISHED BY THESE AGENCIES. IN THE CASE OF A CONFLICT BETWEEN REQUIREMENTS OF OTHER JURISDICTIONAL AGENCIES AND THESE DOCUMENTS, THE MORE STRINGENT REQUIREMENT SHALL APPLY.
- 2. STORE EXCAVATED OR OTHER MATERIALS A MINIMUM OF 2 FEET FROM THE EDGE OF
- GUARD WALLS OR FACES OF TRENCHES 5 FEET DEEP OR GREATER WITH A SHORING SYSTEM. TO PREVENT CAVE-IN.
- 4. PROVIDE AN ADEQUATE MEANS OF EXIT, SUCH AS LADDERS OR STEPS, LOCATED NO MORE THAN 25 FEET OF LATERAL TRAVEL, IN ALL TRENCHES 4 FEET OR MORE DEEP.
- ASSIGN AN AUTHORIZED, AND COMPETENT, REPRESENTATIVE TO CONDUCT DAILY INSPECTIONS OF EXCAVATIONS.
- 6. INSTRUCT ALL EMPLOYEES TO RECOGNIZE AND AVOID THE HAZARDS ASSOCIATED WITH UNDERGROUND CONSTRUCTION ACTIVITIES.
- 7. SUPPLY FRESH AIR TO ALL UNDERGROUND WORK AREAS.
- 8. SHEETING, IF REQUIRED DURING CONSTRUCTION, IS CONSIDERED TO BE PART OF THIS CONTRACT AND PROVIDED AT NO ADDITIONAL COST TO THE OWNER.
- 9. ALL TRENCHES THROUGH PAVEMENT SHALL BE SAW CUT PRIOR TO EXCAVATION AND AGAIN PRIOR TO SURFACE RESTORATION.
- 10. ALL EXCESS EXCAVATED MATERIALS SHALL BE REMOVED FROM THE SITE AND

PROPERLY DISPOSED OF BY THE CONTRACTOR AT NO ADDITIONAL COST TO THE OWNER.

#### **EROSION AND SEDIMENT CONTROL NOTES**

- 1. ALL EROSION CONTROL MEASURES SHALL BE IN ACCORDANCE WITH NEW YORK STANDARDS AND SPECIFICATIONS FOR EROSION AND SEDIMENT CONTROL, AND LOCAL GOVERNING SOIL AND WATER CONSERVATION AGENCY RECOMMENDATIONS AND STANDARDS. CONTRACTOR SHALL SUBMIT PROPOSED EROSION CONTROL PLAN INCLUDING SEQUENCING OF WORK TO THE ARCHITECT/ENGINEER FOR REVIEW PRIOR TO START OF WORK.
- 2. THE CONTRACTOR IS RESPONSIBLE FOR UTILIZING EROSION AND SEDIMENTATION CONTROL TECHNIQUES IN ALL AREAS OF CONSTRUCTION WHERE SEDIMENT LADEN RUNOFF MAY BE GENERATED BY CONSTRUCTION OPERATIONS.
- 3. FOR THE DURATION OF THE PROJECT, PROTECT ALL WETLANDS, STORM SEWERS AND WATER COURSES FROM CONTAMINATION BY WATER BORNE SILTS, SEDIMENTS, FUELS, SOLVENTS, LUBRICANTS OR OTHER POLLUTANTS ORIGINATING FROM ANY WORK DONE ON, OR IN SUPPORT OF THIS PROJECT.
- 4. ALL METHODS AND EQUIPMENT PROPOSED BY THE CONTRACTOR TO ACCOMPLISH THE WORK FOR EROSION AND POLLUTION CONTROL SHALL BE SUBJECT TO APPROVAL OF THE ARCHITECT/ENGINEER.
- 5. CONTRACTOR STAGING AREAS AND CONSTRUCTION ENTRANCE LOCATIONS SHALL BE COORDINATED WITH THE OWNER PRIOR TO START OF CONSTRUCTION.
- 6. PREVENT TRACKING OR FLOWING OF SEDIMENT ONTO PUBLIC RIGHT-OF-WAYS OR INTERFERING WITH THE OPERATION OF THE EXISTING FACILITY. KEEP ALL SIDEWALKS, STREETS, DRIVES, CART PATHS AND OTHER PAVEMENTS CLEAN AND FREE FROM DIRT, MUD, STONES AND OTHER HAULED MATERIALS AS A RESULT OF THE WORK.
- 7. ROADS ARE TO BE KEPT CLEAR OF MUD AND DEBRIS AT ALL TIMES.

#### SANITARY SEWER / FORCE MAIN NOTES

- PERFORM WORK REQUIRED TO VERIFY ALL EXISTING INVERT ELEVATIONS AND SEWERS
  TO BE CONNECTED PRIOR TO THE START OF CONSTRUCTION AND REPORT THE RESULTS
  TO THE ARCHITECT/ENGINEER.
- 2. UTILITY LINES OR APPURTENANT STRUCTURES CROSSING THE AREAS OF EXCAVATION SHALL BE TEMPORARILY SUPPORTED AND OTHERWISE PROTECTED DURING CONSTRUCTION.
- 3. THE NEW SANITARY SEWERS, FORCE MAINS AND MANHOLES MUST PASS LEAKAGE TEST REQUIREMENTS PRIOR TO FINAL ACCEPTANCE. TEST SEWERS WITH LATERALS
- 4. THE NEW FORCE MAIN SHALL BE A MINIMUM OF 6.5' BELOW GRADE.
- 5. ALL SANITARY FORCE MAIN AND LATERALS SHALL BE CONSTRUCTED USING SDR11 HDPE DIPS PIPE IN ACCORDANCE WITH AWWA C901 AND ASTM D3350.
- 6. ALL FITTINGS REQUIRED TO COMPLETE THE WORK ARE NOT INCLUDED ON THE PLANS. THE CONTRACTOR SHALL BE REQUIRED TO PROVIDE AND INSTALL ALL NECESSARY FITTINGS REQUIRED TO COMPLETE THE WORK AT NO ADDITIONAL COST TO THE OWNER.
- 7. WHERE EXISTING SEWERS AND APPURTENANCES ARE ABANDONED OR REMOVED, AND NEW FACILITIES IN THE SAME AREA ARE CONSTRUCTED, THE SEWAGE FLOW SHALL BE BYPASSED THROUGH A SUITABLE CLOSED CONDUIT WITH PUMPS, IF NECESSARY. THIS WORK SHALL BE PERFORMED WITHOUT BACKING UP THE FLOW IN ANY EXISTING SEWER, BASEMENT, BUILDINGS OR PRIVATE FIXTURE AND SHALL MEET ALL REQUIREMENTS OF THE STATE AND LOCAL HEALTH AUTHORITIES.
- 8. THE CONTRACTOR IS RESPONSIBLE FOR THE REMOVAL AND PROPER DISPOSAL OF THE EXISTING SANITARY OR STORM MAINS, STRUCTURES, AND APPURTENANCES AS NEEDED TO COMPLETE THE WORK UNLESS OTHERWISE SHOWN ON THE PLANS.
- 9. WORK WITHIN AN ACTIVE SANITARY CONVEYANCE SYSTEM IS REQUIRED TO COMPLETE THE WORK. THE CONTRACTOR SHALL MAKE HIS OWN ASSESSMENT OF THE CONDITIONS AND SHALL INSTITUTE WHATEVER WORK RULES AND TAKE WHATEVER MEASURES HE DEEMS NECESSARY TO COMPLY WITH OSHA REGULATIONS AND FOR PERMIT REQUIRED CONFINED SPACE.
- 10. THE CONTRACTOR ALONE IS RESPONSIBLE FOR THE DETERMINATION OF THE LOCATION OF ALL LATERALS (STORM AND SANITARY). IT IS ANTICIPATED THAT LATERALS EXIST FOR ALL EXISTING BUILDINGS.
- 11. PIPES CONNECTING TO THE MANHOLE SHALL HAVE A JOINT WITHIN 2'-0" (MAX.) OF THE MANHOLE UNLESS OTHERWISE NOTED.
- 12. CONTINUOUS SANITARY SERVICE MUST BE MAINTAINED THROUGHOUT CONSTRUCTION. PROVIDE TEMPORARY CONNECTIONS (INCLUDING STRUCTURES) TO FACILITATE THE MEANS AND METHODS OF CONSTRUCTION AND PROPOSED PHASING PLAN. THE CONTRACTOR IS RESPONSIBLE TO REMOVE OR ABANDON ALL TEMPORARY CONNECTIONS.

#### TOWN ROADS NOTES

- 1. MATERIAL, EQUIPMENT AND VEHICLES ARE NOT TO BE STORED OR PARKED WITHIN PAVEMENT OF STREETS.
- 2. SAFE AND CONTINUOUS THROUGH TRAFFIC AND INGRESS AND EGRESS FOR PRIVATE DRIVEWAYS, SERVICE ROADS, AND PUBLIC STREETS SHALL BE MAINTAINED THROUGHOUT THE PERIOD OF CONSTRUCTION.
- 3. IF, BY AGREEMENT WITH THE OWNER, A STREET WILL REQUIRE TEMPORARY CLOSING DURING CONSTRUCTION, NOTIFY IN WRITING THE LOCAL AND STATE POLICE, AND LOCAL FIRE DEPARTMENT REGARDING THE CLOSING. ACCESS TO PRIVATE DRIVEWAYS SHALL BE RESTORED AT THE END OF EACH WORK DAY.
- 4. ERECT AND MAINTAIN MPOT SIGNAGE WHILE SEWER CONSTRUCTION IS UNDER WAY.
  ALL EXCAVATIONS LEFT OPEN OVERNIGHT SHALL BE STEEL PLATED.
- 5. MAINTENANCE AND PROTECTION OF TRAFFIC MUST COMPLY WITH THE NEW YORK STATE DEPARTMENT OF TRANSPORTATION "MANUAL OF UNIFORM TRAFFIC CONTROL DEVICES", SECTION 619 OF THE CURRENT NYSDOT STANDARD SPECIFICATIONS AND AS ORDERED BY THE ARCHITECT/ENGINEER.
- 6. NO NIGHT WORK IS ALLOWED UNLESS APPROVED PRIOR TO START OF PROJECT.
  ADDITIONAL MAINTENANCE AND PROTECTION OF TRAFFIC MAY BE REQUIRED INCLUDING
  THE ADDITION OF REFLECTIVE MATERIALS AND LIGHTING.
- 7. IF ELEVATIONS OR DEPTHS OF MATERIALS ARE DETERMINED TO NOT BE IN COMPLIANCE WITH THE CONTRACT PLANS THE CONTRACTOR SHALL TAKE CORRECTIVE ACTIONS AS DETERMINED BY THE ARCHITECT/ENGINEER. THE CONTRACTOR IS SOLELY RESPONSIBLE FOR ALL INSTALLATION.
- 8. THE ROADS TO BE KEPT FREE OF MUD AND DEBRIS AT ALL TIMES.

#### SPECIAL NOTES

- 1. PRIOR TO THE START OF CONSTRUCTION, VIDEO DOCUMENT (USING A DRONE) ENTIRE PROJECT AREA AND PROVIDE THE DOCUMENTATION ON A DIGITAL USB OR PORTABLE HARD DRIVE TO THE TOWN AND THE ENGINEER.
- 2. RESTORE ALL AREAS AS REQUIRED TO EXCAVATE & INSTALL GRINDER PUMPS (PATIOS, PAVERS, FENCING, GRASS, PAVEMENT, ETC) TO PRE CONSTRUCTION CONDITIONS.
  RESTORATION TO BE INCLUDED IN THE COST OF THE GRINDER PUMPS, NO ADDITIONAL PAYMENT WILL BE MADE.
- 3. PROTECT AND SUPPORT ALL EXISTING STRUCTURES AND UTILITY POLES.
- 4. AT LEAST 15 WORKING DAYS PRIOR TO EXPECTED INSTALLATION OF EACH GRINDER PUMP THE CONTRACTOR SHALL CONFIRM ELECTRICAL SERVICE LOCATION AND VOLTAGE WITH HOMEOWNER.
- 5. LOCATION OF EXISTING PRIVATE AND PUBLIC UTILITIES ARE UNKNOWN. CONTRACTOR TO LOCATE, PROTECT AND WORK AROUND ALL EXISTING PRIVATE UTILITIES, AND INCLUDE ALL COSTS IN BID PRICE. NO ADDITIONAL PAYMENT WILL BE MADE TO GO AROUND, UNDER, OR ABOVE, AN EXISTING UTILITY. REPAIR DAMAGE TO ANY EXISTING UTILITY AT NO ADDITIONAL COST.
- PUMP CONTROL / ALARM PANEL LOCATIONS INDICATED ON THE PLANS ARE APPROXIMATE. VERIFY FINAL LOCATION WITH SITE REPRESENTATIVE & HOMEOWNER.
- 7. THE CONTRACTOR IS NOT RESPONSIBLE FOR POWER CONNECTION BETWEEN THE HOMEOWNER'S ELECTRICAL PANEL AND THE GRINDER PUMP ALARM PANEL.
- 8. FACTORY WIRING DIAGRAM OF THE BASIS-OF-DESIGN GRINDER PUMP SYSTEM IS INCLUDED ON SHEET 7/C502.

#### LEGEND

**EXISTING** 

**PROPOSED** 


DESCRIPTION

Δ		PROJECT BENCHMARK / CONTROL POINTS
		BORING LOCATIONS
v	×	OBJECT REMOVAL
	-	REMOVAL/ABANDONMENT
		SAWCUT
		PROTECTION (OBJECT)
		TREE PROTECTION
		FENCE, CHAIN LINK
		FENCE, GUIDE RAIL
		TREE/VEGETATION LIMIT
		NYSDEC WETLAND BUFFER
7//////////////////////////////////////	, DI DO	
annununia.	BLDG	BUILDING/STRUCTURE
— - — £— - —	——————————————————————————————————————	PROPERTY LINE
— – — PE-— – ——	— – — PE — – —	EASEMENTS
R.O.W	R.O.W	RIGHT-OF-WAY
þ	4	SIGN
Ф		BUSH
		DECIDUOUS TREE
*		CONIFEROUS TREE
*		SHRUB
	-	UTILITY POLE
	<del></del>	UTILITY POLE WITH LIGHT
HH	HH	HANDHOLE
E	Œ	MANHOLE
	Р	ALARM PANEL MOUNTED TO STRUCTURE
	P	ALARM PANEL MOUNTED TO POST
	TW	TRACER WIRE BOX
$\wedge$	A	END SECTION
	Ш	CATCH BASIN
$\bigcirc$	•	MANHOLE (SOLID COVER)
CO <sub>o</sub>	CO.	CLEAN OUT
$\triangle$		HYDRANT
×	H	VALVE
$\otimes$		CURB STOP
тт	тт	TELEPHONE LINE
——-UE	UEUE	UNDERGROUND ELECTRIC
		GAS LINE
SASA	SA	SANITARY LINE
FMFM	FM	SANITARY FORCE MAIN
stst	st st	STORM LINE
w	ww	WATER LINE
-5/0-	<b></b> 510 <b></b>	MAJOR CONTOUR
— <i>–509–</i> — –		
		INLET PROTECTION
	<del></del>	EROSION FENCE
	LPSM	LOW PRESSURE SEWER MAIN
		ALARM CONDUIT
		TRACER WIRE BOX
	$\boxtimes$	IRVIER WIRE BLIA

# LaBella Powered by partnership.

300 State Street, Suite 201 Rochester, NY 14614 585-454-6110

labellapc.com

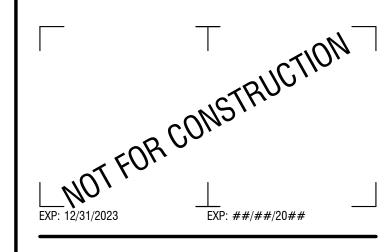

CERTIFICATE OF AUTHORIZATION NUMBER: PROFESSIONAL ENGINEERING: 095099 LAND SURVEYING: 017976 GEOLOGICAL: 018750

It is a violation of New York Education Law Art. 145 Sec. 7209 & Art. 147 Sec. 7307, for any person, unless acting under the direction of a licensed architect, professional engineer, or land surveyor, to alter an item in any way. If an item bearing the seal of an architect, engineer, or land surveyor is altered; the altering architect, engineer, or land surveyor shall affix to the item their seal and notation "altered by" followed by their signature and date of such alteration, and a specific description of the alteration.

© 2023 LaBella Associates



#### REDI WASTEWATEF INFRASTRUCTURE (CONTRACT 1)

TOWN OF KENDALL & TOWN OF HAMLIN

NO:	DATE:	DESCRIPTION:
Davilalana	•	
Revisions		

DRAWN BY: JCP

REVIEWED BY: JRE

PROJECT NUMBER:

DATE:

DRAWING NAME:

60% DESIGN SUBMISSION

SEPTEMBER 2023


**GENERAL NOTES & LEGEND** 

DRAWING NUMBER:

LOW PRESSURE SEWER PLAN

HORIZ: 1' = 50'



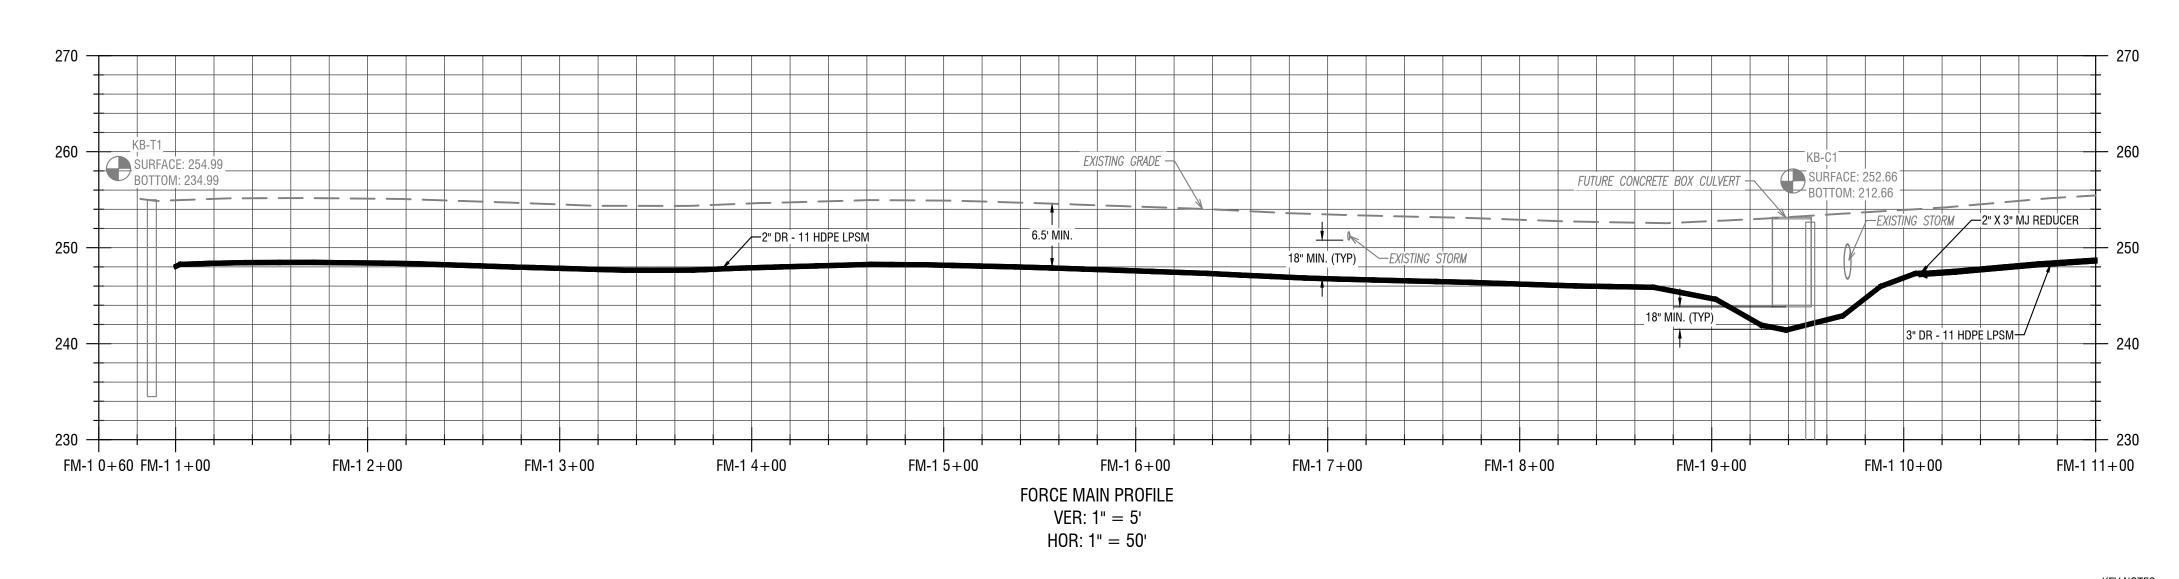

2 LOW PRESSURE SEWER PROFILE

C301 VERT: 1' = 10' HORIZ: 1' = 50' KEY NOTES


- 1 GRINDER PUMPS WITH REMOTE VENTING
- 2 INSTALL ALARM PANEL (FURNISHED BY OWNER), MOUNTED TO HOUSE
- MOUNTED TO HOUSE

  INSTALL ALARM PANEL (FURNISHED BY OWNER),
  MOUNTED TO POST
- PROVIDE ONE 3", PVC CONDUIT BETWEEN THE PUMP CONTROL / ALARM PANEL & THE GRINDER PUMP. INSTALL ELECTRICAL SUPPLY CABLE (ESC) PROVIDED WITH PUMP CONNECT TO GRINDER PUMP AND CONTROL / ALARM PANEL.

LaBella
Powered by partnership.

300 State Street, Suite 201 Rochester, NY 14614 585-454-6110


labellapc.com

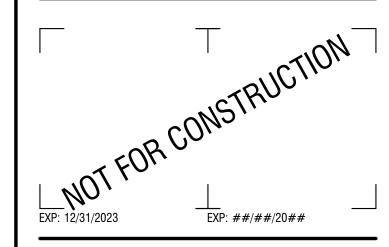

CERTIFICATE OF AUTHORIZATION NUMBER: PROFESSIONAL ENGINEERING: 095099 LAND SURVEYING: 017976 GEOLOGICAL: 018750

It is a violation of New York Education Law Art. 145 Sec. 7209 & Art. 147 Sec. 7307, for any person, unless acting under the direction of a licensed architect, professional engineer, or land surveyor, to alter an item in any way. If an item bearing the seal of an architect, engineer, or land surveyor is altered; the altering architect, engineer, or land surveyor shall affix to the item their seal and notation "altered by" followed by their signature and date of such alteration, and a specific description of the alteration.

© 2023 LaBella Associates

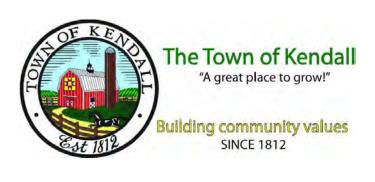


### REDI WASTEWATER INFRASTRUCTURE (CONTRACT 1)

TOWN OF KENDALL & TOWN OF HAMLIN

NO:	DATE:	DESCRIPTION:
Revisions		
PROJECT N	IUMBER:	2200455
DRAWN BY	:	IOD
REVIEWED	RV·	JCB
TILVILVVLD DI.	51.	JRE
ISSUED FO		DESIGN SUBMISSION
	00 /0 1	
DATE:	c	EPTEMBER 2023
	ა	EFICIVIDEN 2023
DRAWING I	NAME:	

# LOW PRESSURE SEWER PLAN & PROFILES (THOMPSON DRIVE)

DRAWING NUMBER:

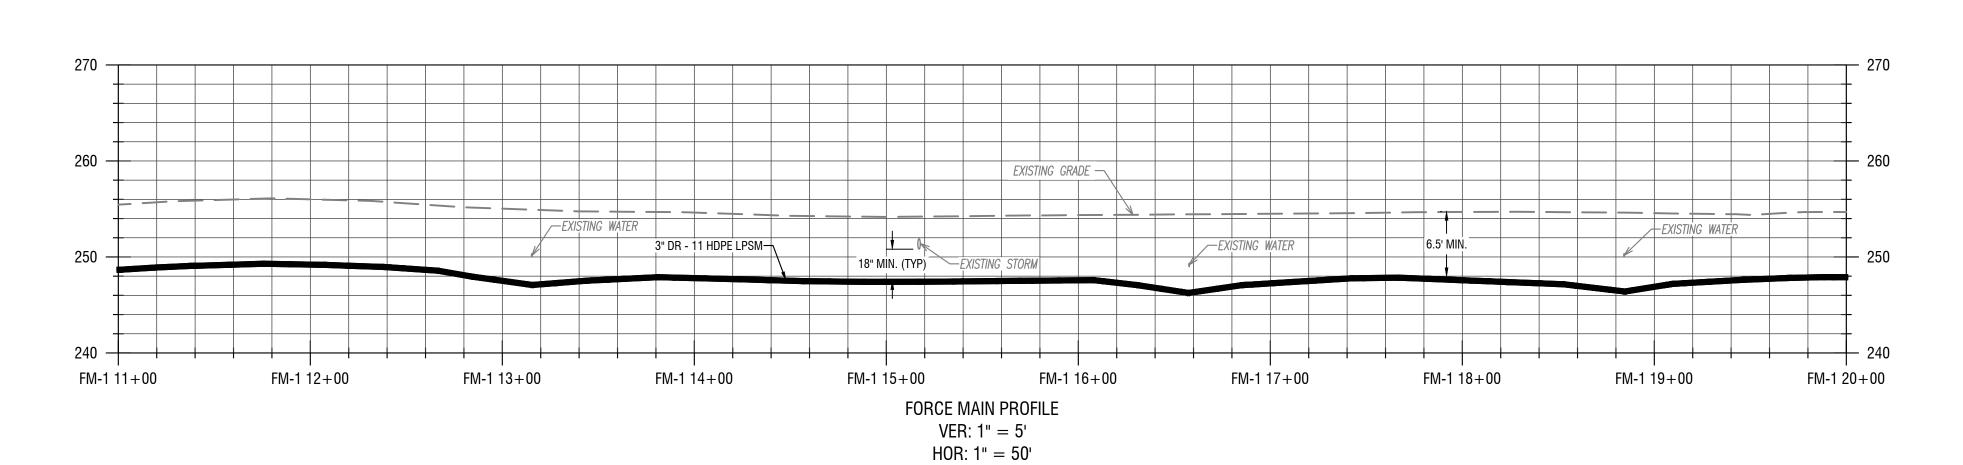

LOW PRESSURE SEWER PROFILE

LOW PRESSURE SEWER PLAN

C302 HORIZ: 1' = 50'

C302 VERT: 1' = 10' HORIZ: 1' = 50'

KEY NOTES


SCALE: 1" = 50'

- 1 GRINDER PUMPS WITH REMOTE VENTING
- 2 INSTALL ALARM PANEL (FURNISHED BY OWNER), MOUNTED TO HOUSE
- install alarm panel (furnished by owner), mounted to post
- PROVIDE ONE  $\frac{3}{4}$ ", PVC CONDUIT BETWEEN THE PUMP CONTROL / ALARM PANEL & THE GRINDER PUMP. INSTALL ELECTRICAL SUPPLY CABLE (ESC) PROVIDED WITH PUMP - CONNECT TO GRINDER PUMP AND CONTROL / ALARM PANEL.

Powered by partnership.

300 State Street, Suite 201 Rochester, NY 14614 585-454-6110


labellapc.com

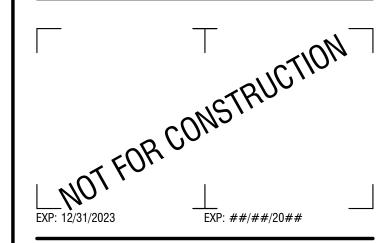

CERTIFICATE OF AUTHORIZATION NUMBER: PROFESSIONAL ENGINEERING: 095099 LAND SURVEYING: 017976 GEOLOGICAL: 018750

It is a violation of New York Education Law Art. 145 Sec. 7209 & Art. 147 Sec. 7307, for any person, unless acting under the direction of a licensed architect, professional engineer, or land surveyor, to alter an item in any way. If an item bearing the seal of an architect, engineer, or land surveyor is altered; the altering architect, engineer, or land surveyor shall affix to the item their seal and notation "altered by" followed by their signature and date of such alteration, and a specific description of the alteration.

© 2023 LaBella Associates

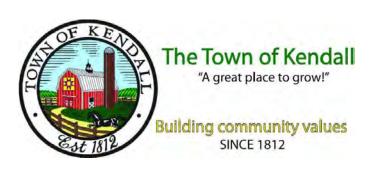


# **REDI WASTEWATER INFRASTRUCTURE** (CONTRACT 1)

TOWN OF KENDALL & TOWN OF HAMLIN

NO:	DATE:	DESCRIPTION:
Revisions		
PROJECT NU	MBER:	2200455
DRAWN BY:		100
REVIEWED B	٧٠	JCB
NEVIEWED D		JRE
ISSUED FOR:		
	60% 1	DESIGN SUBMISSION
DATE:	0	EDTEMBED 2022
	5	EPTEMBER 2023
DRAWING NA	AME:	

# LOW PRESSURE SEWER PLAN & PROFILES (THOMPSON DRIVE)



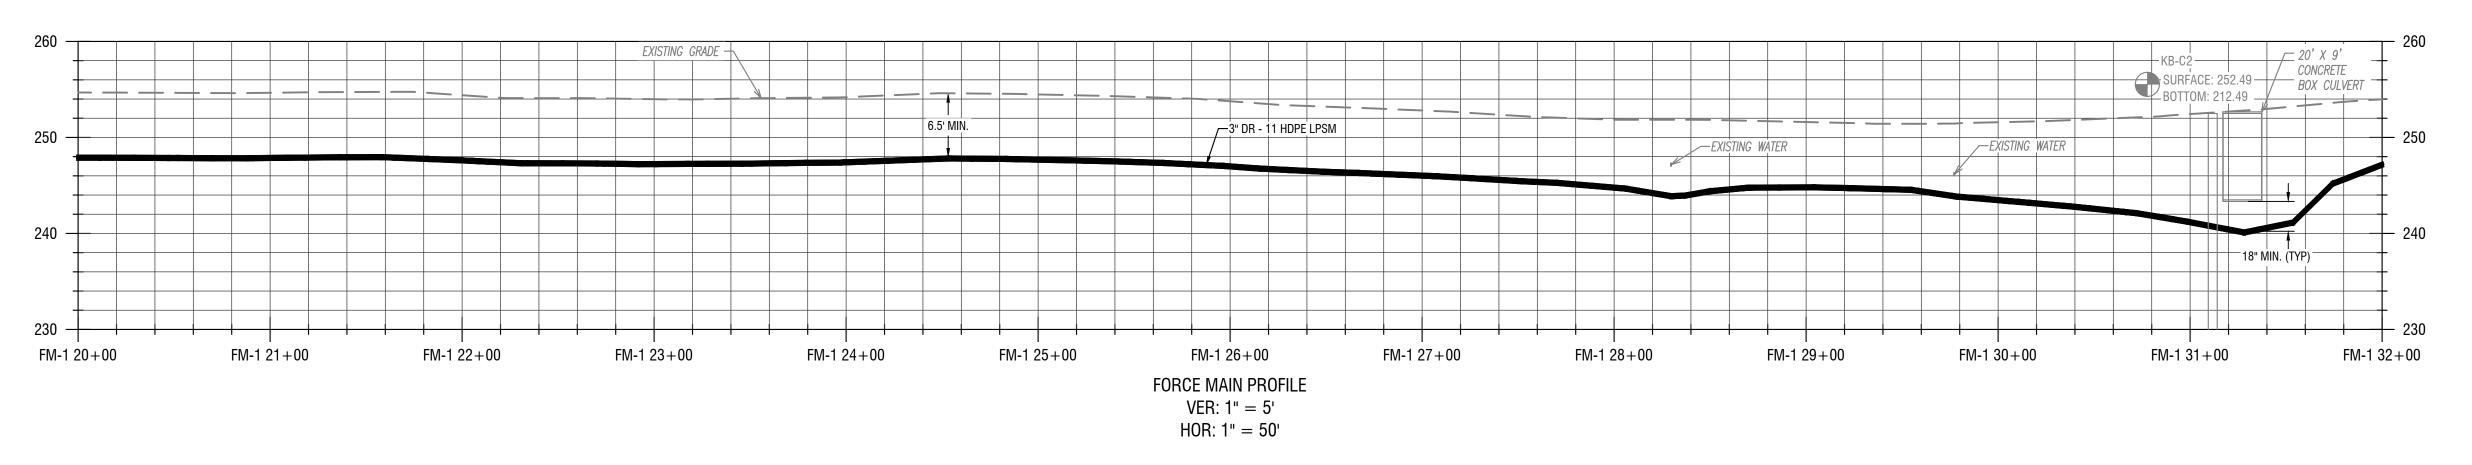

2 LOW PRESSURE SEWER PROFILE

C303 VERT: 1' = 10'
HORIZ: 1' = 50'

KEY NOTES

PANEL.


- 1 GRINDER PUMPS WITH REMOTE VENTING
- 2 INSTALL ALARM PANEL (FURNISHED BY OWNER), MOUNTED TO HOUSE
- MOUNTED TO HOUSE

  INSTALL ALARM PANEL (FURNISHED BY OWNER),
  MOUNTED TO POST
- PROVIDE ONE 3/4", PVC CONDUIT BETWEEN THE PUMP CONTROL / ALARM PANEL & THE GRINDER PUMP. INSTALL ELECTRICAL SUPPLY CABLE (ESC) PROVIDED WITH PUMP CONNECT TO GRINDER PUMP AND CONTROL / ALARM

LaBella
Powered by partnership.

300 State Street, Suite 201 Rochester, NY 14614 585-454-6110

labellapc.com

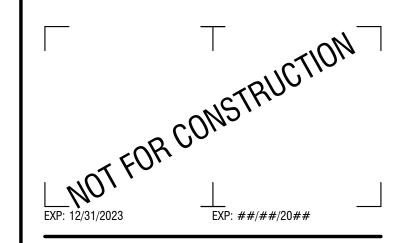

CERTIFICATE OF AUTHORIZATION NUMBER: PROFESSIONAL ENGINEERING: 095099 LAND SURVEYING: 017976 GEOLOGICAL: 018750

It is a violation of New York Education Law Art. 145 Sec. 7209 & Art. 147 Sec. 7307, for any person, unless acting under the direction of a licensed architect, professional engineer, or land surveyor, to alter an item in any way. If an item bearing the seal of an architect, engineer, or land surveyor is altered; the altering architect, engineer, or land surveyor shall affix to the item their seal and notation "altered by" followed by their signature and date of such alteration, and a specific description of the alteration.

© 2023 LaBella Associates



# REDI WASTEWATER INFRASTRUCTURE (CONTRACT 1)

TOWN OF KENDALL & TOWN OF HAMLIN


NO:	DATE:	DESCRIPTION:
Revisions		
PROJECT NUI	MBER:	2200455
DRAWN BY:		
REVIEWED BY	<b>/</b> .	JCB
REVIEWED BY:	•	JRE
ISSUED FOR:	60% I	DESIGN SUBMISSION
DATE:		
	S	EPTEMBER 2023
DRAWING NA	MF·	

# LOW PRESSURE SEWER PLAN & PROFILES (KNAPP SHORE)

DRAWING NUMBER:

LOW PRESSURE SEWER PLAN C304 HORIZ: 1' = 50'



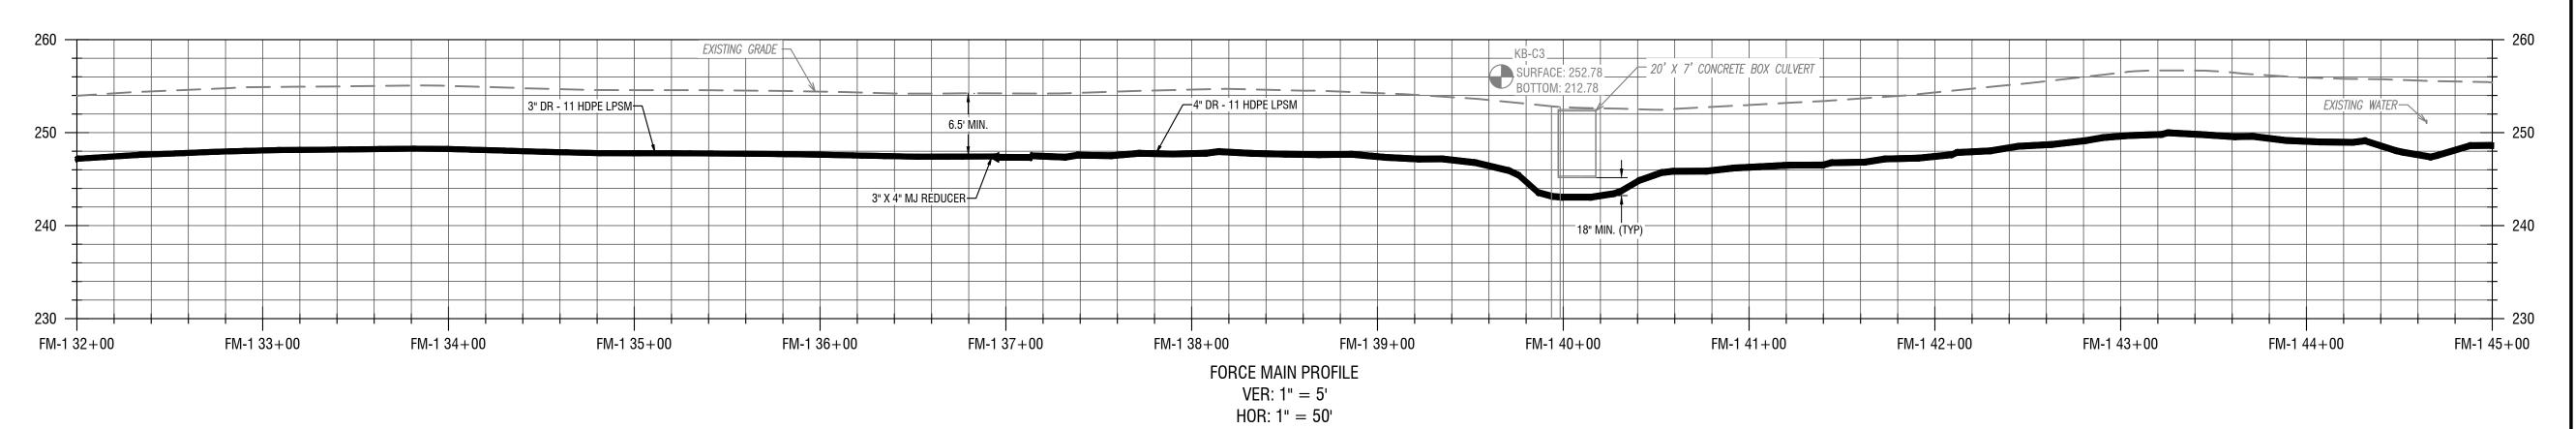

LOW PRESSURE SEWER PROFILE C304 /

VERT: 1' = 10' HORIZ: 1' = 50' KEY NOTES


- 1 GRINDER PUMPS WITH REMOTE VENTING
- 2 INSTALL ALARM PANEL (FURNISHED BY OWNER), MOUNTED TO HOUSE
- 3 INSTALL ALARM PANEL (FURNISHED BY OWNER), MOUNTED TO POST
- PROVIDE ONE  $\frac{3}{4}$ , PVC CONDUIT BETWEEN THE PUMP CONTROL / ALARM PANEL & THE

GRINDER PUMP. INSTALL ELECTRICAL SUPPLY CABLE (ESC) PROVIDED WITH PUMP - CONNECT TO GRINDER PUMP AND CONTROL / ALARM PANEL.

Powered by partnership.

300 State Street, Suite 201 Rochester, NY 14614 585-454-6110

labellapc.com

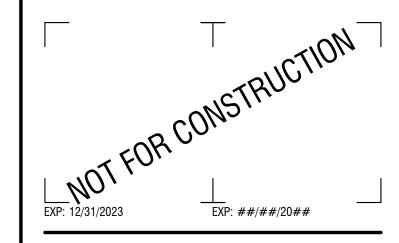

CERTIFICATE OF AUTHORIZATION NUMBER: PROFESSIONAL ENGINEERING: 095099 LAND SURVEYING: 017976 GEOLOGICAL: 018750

It is a violation of New York Education Law Art. 145 Sec. 7209 & Art. 147 Sec. 7307, for any person, unless acting under the direction of a licensed architect, professional engineer, or land surveyor, to alter an item in any way. If an item bearing the seal of an architect, engineer, or land surveyor is altered; the altering architect, engineer, or land surveyor shall affix to the item their seal and notation "altered by" followed by their signature and date of such alteration, and a specific description of the alteration.

© 2023 LaBella Associates




### **REDI WASTEWATER INFRASTRUCTURE** (CONTRACT 1)

TOWN OF KENDALL & TOWN OF HAMLIN

NO:	DATE:	DATE: DESCRIPTION:		
Revisions				
PROJECT NU	JMBER:	2200455		
DRAWN BY:				
DEVIEWED E	)V-	JCB		
REVIEWED BY:	οτ.	JRE		
ISSUED FOR		DECION CURMICOLON		
	6U% I	DESIGN SUBMISSION		
DATE:	0			
	5	EPTEMBER 2023		
DRAWING N.	AME:			

# LOW PRESSURE SEWER PLAN & PROFILES (KNAPP SHORE)

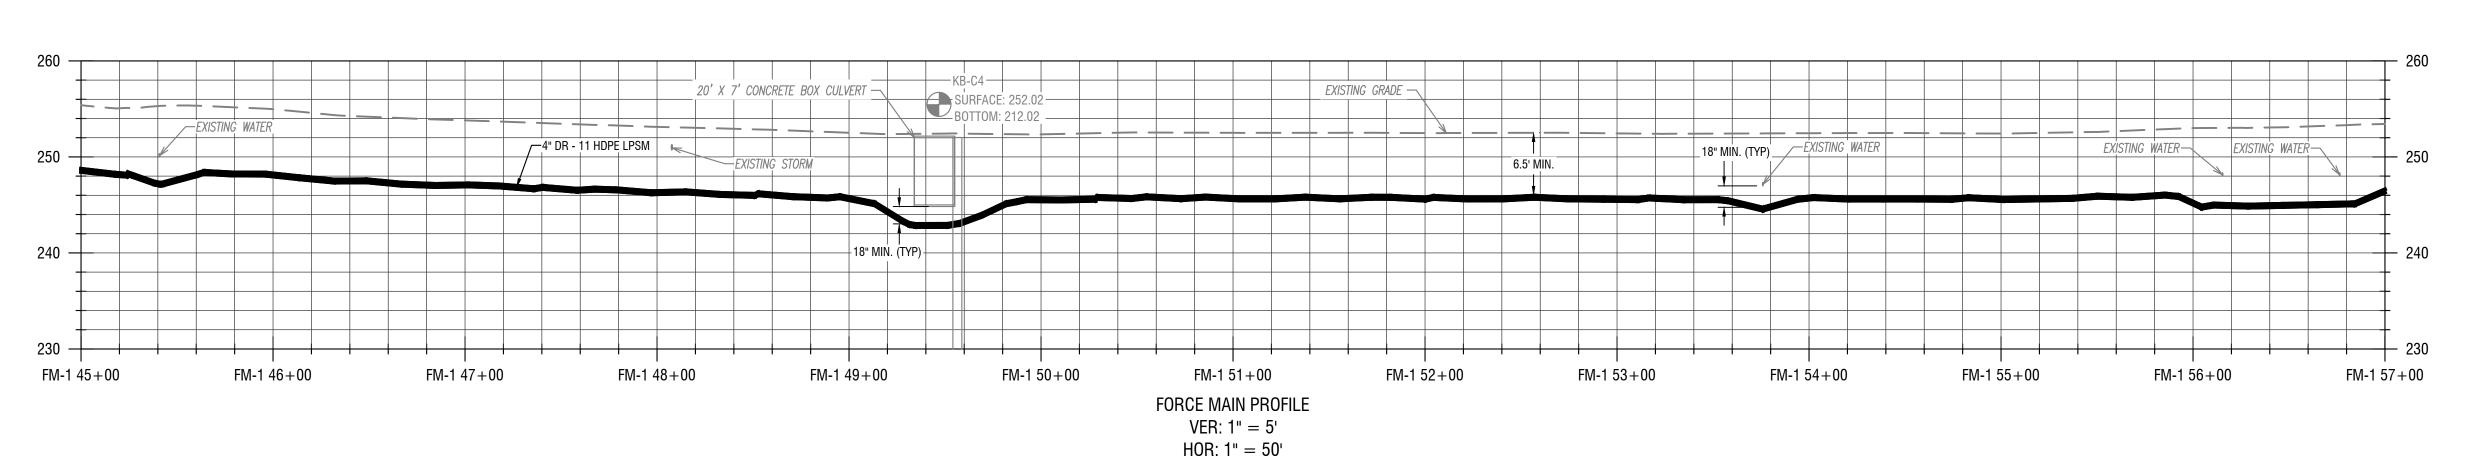


LOW PRESSURE SEWER PROFILE

C305 VERT: 1' = 10' HORIZ: 1' = 50' KEY NOTES

- 1 GRINDER PUMPS WITH REMOTE VENTING
- 2 INSTALL ALARM PANEL (FURNISHED BY OWNER), MOUNTED TO HOUSE
- install alarm panel (furnished by owner), mounted to post
- PROVIDE ONE  $\frac{3}{4}$ ", PVC CONDUIT BETWEEN THE PUMP CONTROL / ALARM PANEL & THE GRINDER PUMP. INSTALL ELECTRICAL SUPPLY CABLE (ESC) PROVIDED WITH PUMP - CONNECT TO GRINDER PUMP AND CONTROL / ALARM PANEL.

300 State Street, Suite 201 Rochester, NY 14614 585-454-6110

labellapc.com

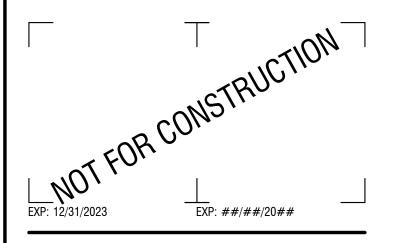

CERTIFICATE OF AUTHORIZATION NUMBER: PROFESSIONAL ENGINEERING: 095099 LAND SURVEYING: 017976 GEOLOGICAL: 018750

It is a violation of New York Education Law Art. 145 Sec. 7209 & Art. 147 Sec. 7307, for any person, unless acting under the direction of a licensed architect, professional engineer, or land surveyor, to alter an item in any way. If an item bearing the seal of an architect, engineer, or land surveyor is altered; the altering architect, engineer, or land surveyor shall affix to the item their seal and notation "altered by" followed by their signature and date of such alteration, and a specific description of the alteration.

© 2023 LaBella Associates




# **REDI WASTEWATER INFRASTRUCTURE** (CONTRACT 1)

TOWN OF KENDALL & TOWN OF HAMLIN

NO:	DATE:	DESCRIPTION:
Revisions		
PROJECT N	IUMBER:	2200455
DRAWN BY	<b>7</b> :	100
REVIEWED	RV·	JCB
NEVIEWED DT.	DI.	JRE
ISSUED FO		DESIGN SUBMISSION
DATE:	(	SEPTEMBER 2023

# LOW PRESSURE SEWER PLAN & PROFILES (EDROSE SHORE)

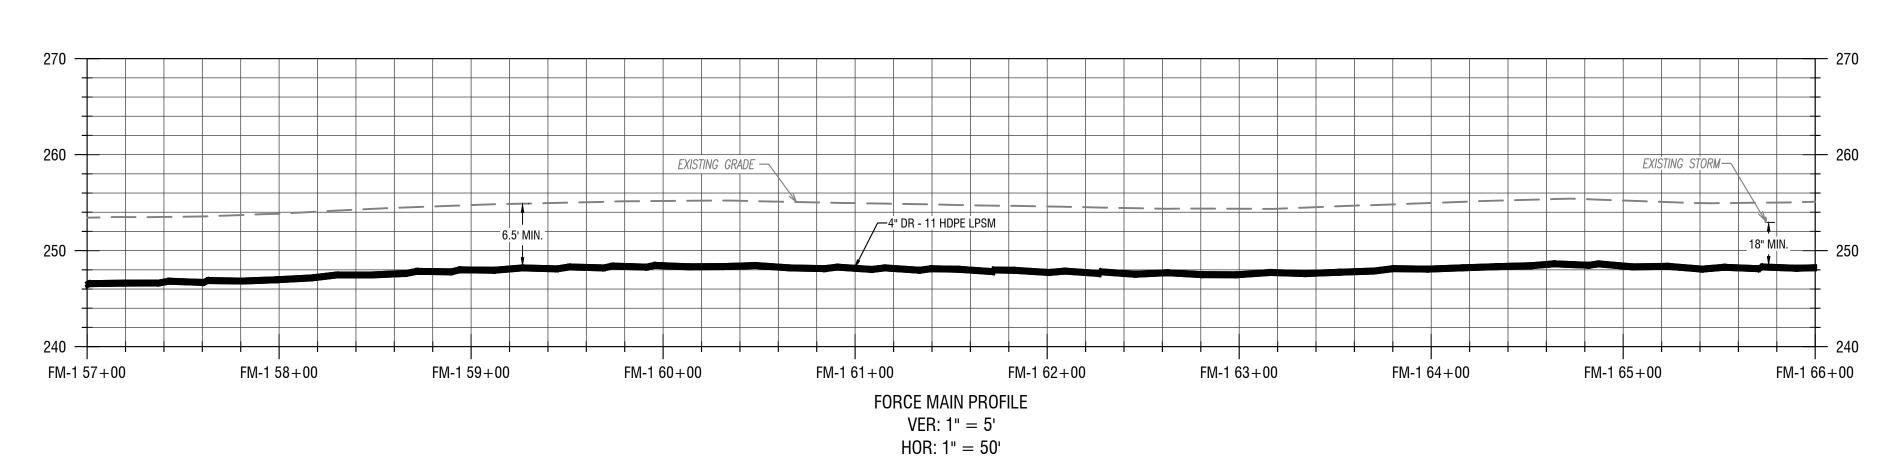

2 LOW PRESSURE SEWER PROFILE

C306 VERT: 1' = 10'
HORIZ: 1' = 50'

LOW PRESSURE SEWER PLAN

C306 HORIZ: 1' = 50'

KEY NOTES

PANEL.


SCALE: 1" = 50'

- (1) GRINDER PUMPS WITH REMOTE VENTING
- 2 INSTALL ALARM PANEL (FURNISHED BY OWNER), MOUNTED TO HOUSE
- install Alarm Panel (Furnished by Owner), mounted to post
- PROVIDE ONE  $\frac{3}{4}$ ", PVC CONDUIT BETWEEN THE PUMP CONTROL / ALARM PANEL & THE GRINDER PUMP. INSTALL ELECTRICAL SUPPLY CABLE (ESC) PROVIDED WITH PUMP CONNECT TO GRINDER PUMP AND CONTROL / ALARM

LaBella
Powered by partnership.

300 State Street, Suite 201 Rochester, NY 14614 585-454-6110


labellapc.com

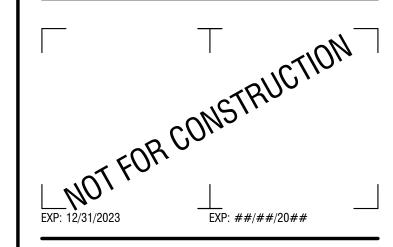

CERTIFICATE OF AUTHORIZATION NUMBER: PROFESSIONAL ENGINEERING: 095099 LAND SURVEYING: 017976 GEOLOGICAL: 018750

It is a violation of New York Education Law Art. 145 Sec. 7209 & Art. 147 Sec. 7307, for any person, unless acting under the direction of a licensed architect, professional engineer, or land surveyor, to alter an item in any way. If an item bearing the seal of an architect, engineer, or land surveyor is altered; the altering architect, engineer, or land surveyor shall affix to the item their seal and notation "altered by" followed by their signature and date of such alteration, and a specific description of the alteration.

© 2023 LaBella Associates

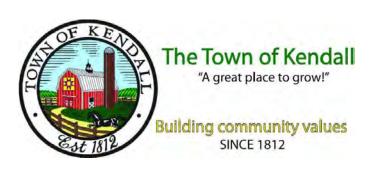

# REDI WASTEWATER INFRASTRUCTURE (CONTRACT 1)

TOWN OF KENDALL & TOWN OF HAMLIN


NO:	DATE:	DESCRIPTION:
Revisions		
PROJECT NU	JMBER:	2200455
DRAWN BY:		
REVIEWED E	ov.	JCB
REVIEWED DY.	η.	JRE
ISSUED FOR		
	60%	DESIGN SUBMISSION
DATE:		PEDTEMBED 0000
	5	SEPTEMBER 2023
DRAWING N	AME:	

# LOW PRESSURE SEWER PLAN & PROFILES (EDROSE SHORE)

DRAWING NUMBER:

C306

\\cash.lab\p\PAM7\Kendall, Town of\2200455 - REDI Wastewater Infrastructure\Drawings\Civil\01 CONTRACT NO 1. (LPSM COLLECTION)\C300 - THOMPSON-KNAPP-ENROSE-L∟

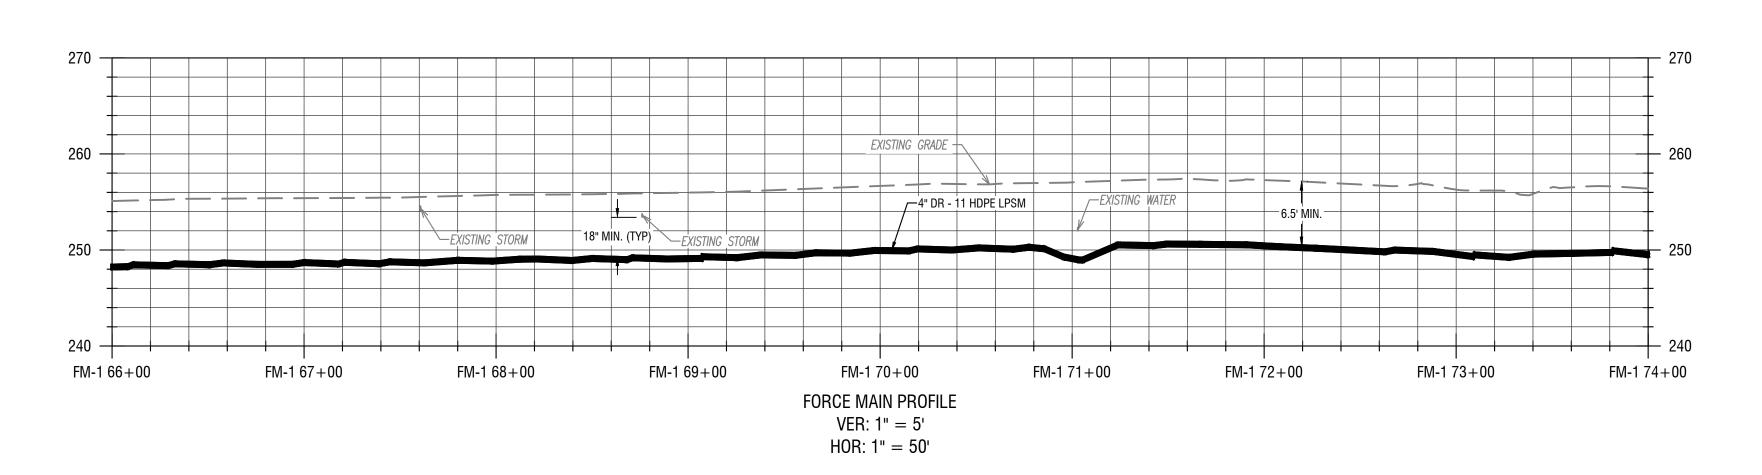

SCALE: 1" = 50'

2 LOW PRESSURE SEWER PROFILE

C307 VERT: 1' = 10'
HORIZ: 1' = 50'


LOW PRESSURE SEWER PLAN

C307 HORIZ: 1' = 50'

LaBella
Powered by partnership.

300 State Street, Suite 201 Rochester, NY 14614 585-454-6110

labellapc.com

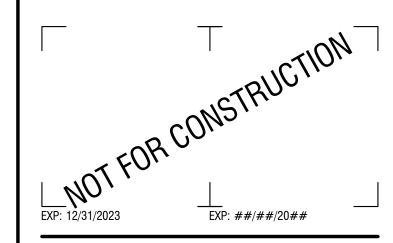

CERTIFICATE OF AUTHORIZATION NUMBER: PROFESSIONAL ENGINEERING: 095099 LAND SURVEYING: 017976 GEOLOGICAL: 018750

It is a violation of New York Education Law Art. 145 Sec. 7209 & Art. 147 Sec. 7307, for any person, unless acting under the direction of a licensed architect, professional engineer, or land surveyor, to alter an item in any way. If an item bearing the seal of an architect, engineer, or land surveyor is altered; the altering architect, engineer, or land surveyor shall affix to the item their seal and notation "altered by" followed by their signature and date of such alteration, and a specific description of the alteration.

© 2023 LaBella Associates



### REDI WASTEWATER INFRASTRUCTURE (CONTRACT 1)

TOWN OF KENDALL & TOWN OF HAMLIN

NO:	DATE:	DESCRIPTION:
Revisions		
PROJECT NU	MBER:	2200455
DRAWN BY:		
REVIEWED B	٧٠	JCB
REVIEWED BY:	1.	JRE
ISSUED FOR:		DESIGN SUBMISSION
DATE:	S	EPTEMBER 2023
DRAWING NA	AME:	

# LOW PRESSURE SEWER PLAN & PROFILES (EDROSE SHORE)

DRAWING NUMBER:

KEY NOTES

PANEL.

1 GRINDER PUMPS WITH REMOTE VENTING

2 INSTALL ALARM PANEL (FURNISHED BY OWNER), MOUNTED TO HOUSE


(3) INSTALL ALARM PANEL (FURNISHED BY OWNER), MOUNTED TO POST

GRINDER PUMP. INSTALL ELECTRICAL SUPPLY CABLE (ESC) PROVIDED WITH PUMP - CONNECT TO GRINDER PUMP AND CONTROL / ALARM

PROVIDE ONE  $\frac{3}{4}$ , PVC CONDUIT BETWEEN THE PUMP CONTROL / ALARM PANEL & THE

C307

\\cash.lab\p\PAM7\Kendall, Town of\2200455 - REDI Wastewater Infrastructure∖Drawings\Civil∖01 CONTRACT NO 1. (LPSM COLLECTION)\C300 - THOMPSON-KNAPP-EN

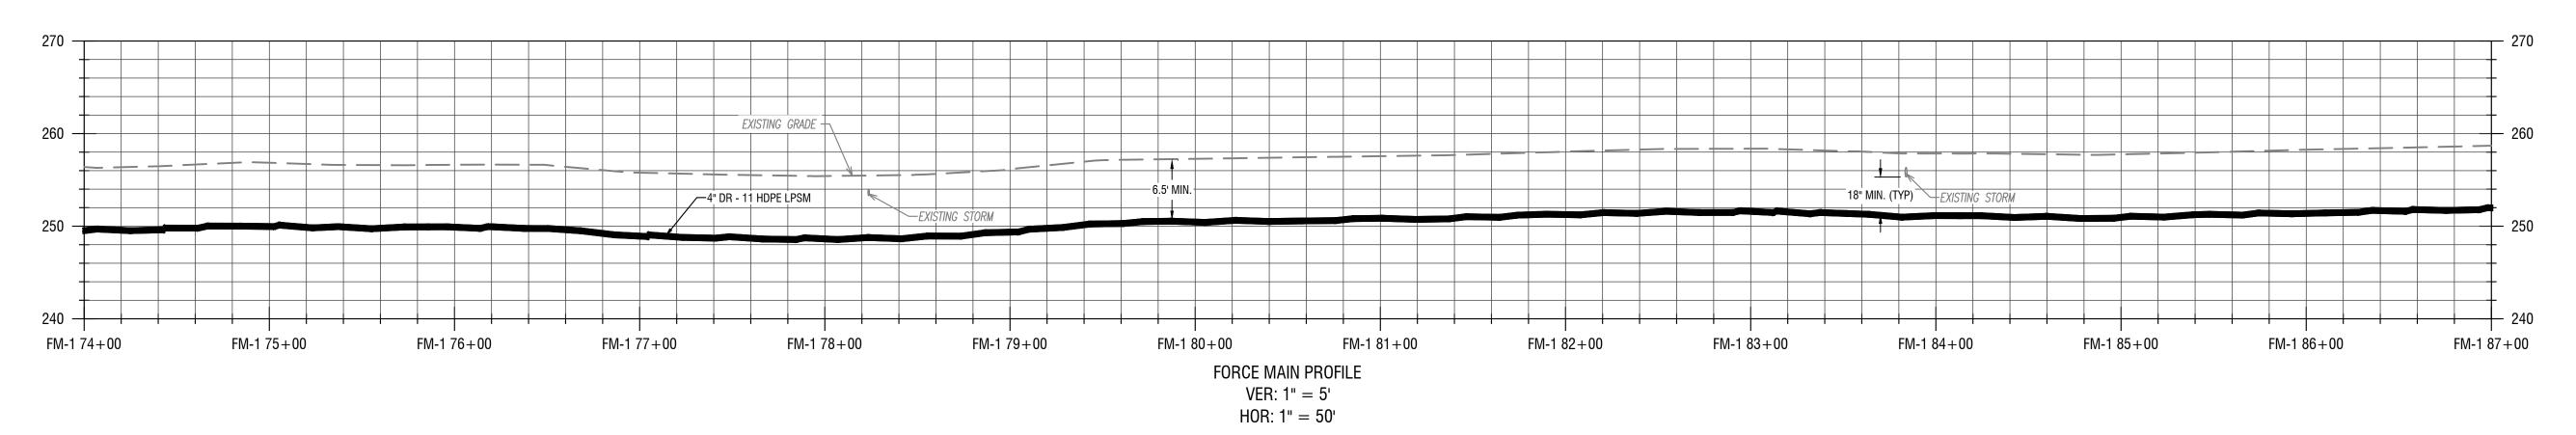

2 LOW PRESSURE SEWER PROFILE

C308 VERT: 1' = 10'
HORIZ: 1' = 50'

GRINDER PUMPS WITH REMOTE VENTING

KEY NOTES

2 INSTALL ALARM PANEL (FURNISHED BY OWNER), MOUNTED TO HOUSE


INSTALL ALARM PANEL (FURNISHED BY OWNER),
MOUNTED TO POST

PROVIDE ONE 3/4", PVC CONDUIT BETWEEN THE PUMP CONTROL / ALARM PANEL & THE GRINDER PUMP. INSTALL ELECTRICAL SUPPLY CABLE (ESC) PROVIDED WITH PUMP - CONNECT TO GRINDER PUMP AND CONTROL / ALARM PANEL.

LaBella Powered by partnership

300 State Street, Suite 201 Rochester, NY 14614 585-454-6110


labellapc.com

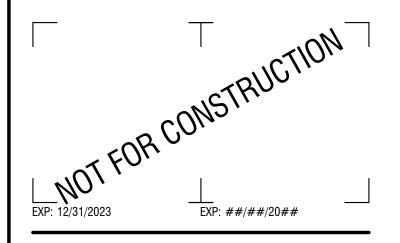

CERTIFICATE OF AUTHORIZATION NUMBER: PROFESSIONAL ENGINEERING: 095099 LAND SURVEYING: 017976 GEOLOGICAL: 018750

It is a violation of New York Education Law Art. 145 Sec. 7209 & Art. 147 Sec. 7307, for any person, unless acting under the direction of a licensed architect, professional engineer, or land surveyor, to alter an item in any way. If an item bearing the seal of an architect, engineer, or land surveyor is altered; the altering architect, engineer, or land surveyor shall affix to the item their seal and notation "altered by" followed by their signature and date of such alteration, and a specific description of the alteration.

© 2023 LaBella Associates

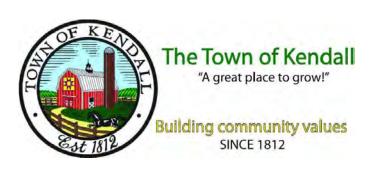

#### REDI WASTEWATER INFRASTRUCTURE (CONTRACT 1)

TOWN OF KENDALL & TOWN OF HAMLIN

NO:	DATE:	DESCRIPTION:
Revisions		
PROJECT N	UMBER:	2200455
DRAWN BY:		
חבייוריאיבה ו	DV.	JCB
REVIEWED BY:	BY:	JRE
ISSUED FOF		DESIGN SUBMISSION
DATE:	5	SEPTEMBER 2023

# LOW PRESSURE SEWER PLAN & PROFILES (LOMOND SHORE)

DRAWING NUMBER:

C308

\\cash.lab\p\PAM7\Kendall, Town of\2200455 - REDI Wastewater Infrastructure∖Drawings\Civil∖01 CONTRACT NO 1. (LPSM COLLECTION)\C300 - THOMPSON-KNAPP-ENROSE-L∟

EXISTING GRADE -6.5' MIN. —18" MIN. (TYP) \_\_EXISTING\_WATER EXISTING WATER— \_\_EXISTING WATER FM-1 92+00 FM-1 89+00 FM-187+00FM-190+00FM-195+00FM-1 96+00 FM-1 97+00 FM-1 98+00 FM-1 99+00 FM-1 99+50 FM-188+00FM-1 91+00 FM-193+00FM-1 94+00 FORCE MAIN PROFILE VER: 1'' = 5'HOR: 1" = 50'

> LOW PRESSURE SEWER PROFILE C309 VERT: 1' = 10'

HORIZ: 1' = 50'

LOW PRESSURE SEWER PLAN

C309 HORIZ: 1' = 50'


KEY NOTES

SCALE: 1" = 50'

- 1 GRINDER PUMPS WITH REMOTE VENTING
- 2 INSTALL ALARM PANEL (FURNISHED BY OWNER), MOUNTED TO HOUSE
- install alarm panel (furnished by owner), mounted to post
- PROVIDE ONE  $\frac{3}{4}$ , PVC CONDUIT BETWEEN THE PUMP CONTROL / ALARM PANEL & THE GRINDER PUMP. INSTALL ELECTRICAL SUPPLY CABLE (ESC) PROVIDED WITH PUMP - CONNECT TO GRINDER PUMP AND CONTROL / ALARM PANEL.

300 State Street, Suite 201 Rochester, NY 14614 585-454-6110

labellapc.com

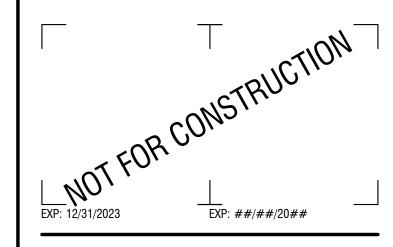

CERTIFICATE OF AUTHORIZATION NUMBER: PROFESSIONAL ENGINEERING: 095099 LAND SURVEYING: 017976 GEOLOGICAL: 018750

It is a violation of New York Education Law Art. 145 Sec. 7209 & Art. 147 Sec. 7307, for any person, unless acting under the direction of a licensed architect, professional engineer, or land surveyor, to alter an item in any way. If an item bearing the seal of an architect, engineer, or land surveyor is altered; the altering architect, engineer, or land surveyor shall affix to the item their seal and notation "altered by" followed by their signature and date of such alteration, and a specific description of the alteration.

© 2023 LaBella Associates




### **REDI WASTEWATER INFRASTRUCTURE** (CONTRACT 1)

TOWN OF KENDALL & TOWN OF HAMLIN

NO:	DATE:	DESCRIPTION:
Revisions		
PROJECT NUM	IBER:	2200455
DRAWN BY:		
REVIEWED BY		JCB
REVIEWED BY:	•	JRE
ISSUED FOR:	60% I	DESIGN SUBMISSION
DATE:	S	EPTEMBER 2023
DRAWING NAM	ΛΕ:	

# LOW PRESSURE SEWER PLAN & PROFILES (LOMOND SHORE)

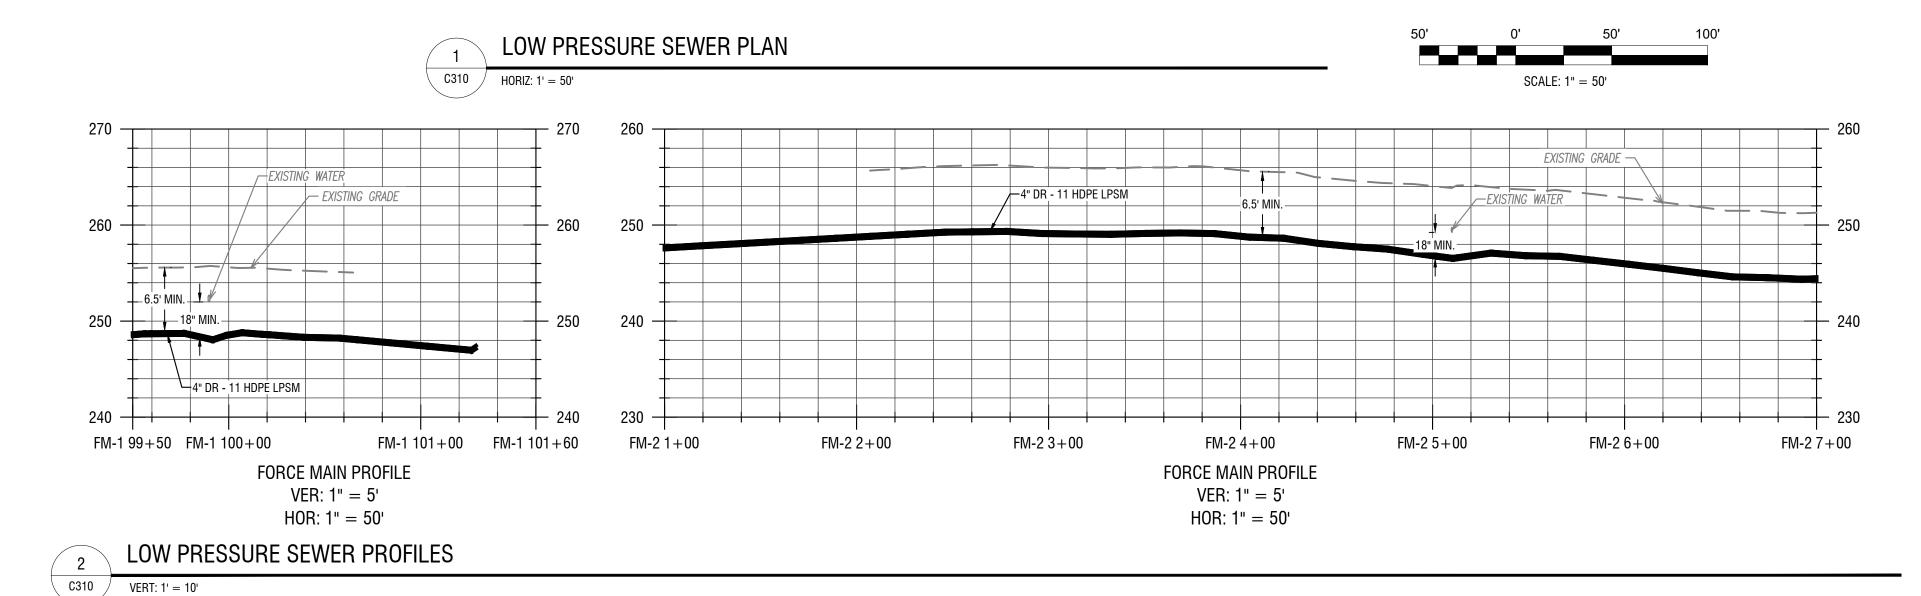

LOW PRESSURE SEWER PROFILE

C310 VERT: 1' = 10' HORIZ: 1' = 50'

HORIZ: 1' = 50'


KEY NOTES

- 1 GRINDER PUMPS WITH REMOTE VENTING
- 2 INSTALL ALARM PANEL (FURNISHED BY OWNER), MOUNTED TO HOUSE
- 3 INSTALL ALARM PANEL (FURNISHED BY OWNER), MOUNTED TO POST
- PROVIDE ONE 3/4", PVC CONDUIT BETWEEN THE PUMP CONTROL / ALARM PANEL & THE GRINDER PUMP. INSTALL ELECTRICAL SUPPLY CABLE (ESC) PROVIDED WITH PUMP CONNECT TO GRINDER PUMP AND CONTROL / ALARM PANEL.

LaBella
Powered by partnership

300 State Street, Suite 201 Rochester, NY 14614 585-454-6110

labellapc.com

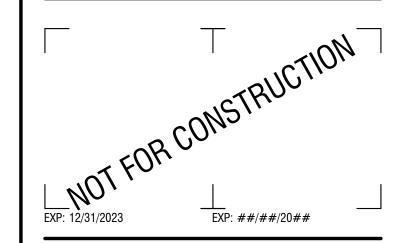

CERTIFICATE OF AUTHORIZATION NUMBER: PROFESSIONAL ENGINEERING: 095099 LAND SURVEYING: 017976 GEOLOGICAL: 018750

It is a violation of New York Education Law Art. 145 Sec. 7209 & Art. 147 Sec. 7307, for any person, unless acting under the direction of a licensed architect, professional engineer, or land surveyor, to alter an item in any way. If an item bearing the seal of an architect, engineer, or land surveyor is altered; the altering architect, engineer, or land surveyor shall affix to the item their seal and notation "altered by" followed by their signature and date of such alteration, and a specific description of the alteration.

© 2023 LaBella Associates



### REDI WASTEWATER INFRASTRUCTURE (CONTRACT 1)

TOWN OF KENDALL & TOWN OF HAMLIN

NO: D	ATE:	DESCRIPTION:	
Revisions			
PROJECT NUMB	ER:	2200455	
DRAWN BY:			
DEVIEWED DV		JCB	
REVIEWED BY:		JRE	
ISSUED FOR:	60% I	DESIGN SUBMISSION	

SEPTEMBER 2023


DRAWING NAME:


DATE:

# LOW PRESSURE SEWER PLAN & PROFILES (LOMOND SHORE)

DRAWING NUMBER:

LOW PRESSURE SEWER PLAN C311 / HORIZ: 1' = 50'

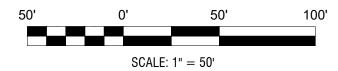

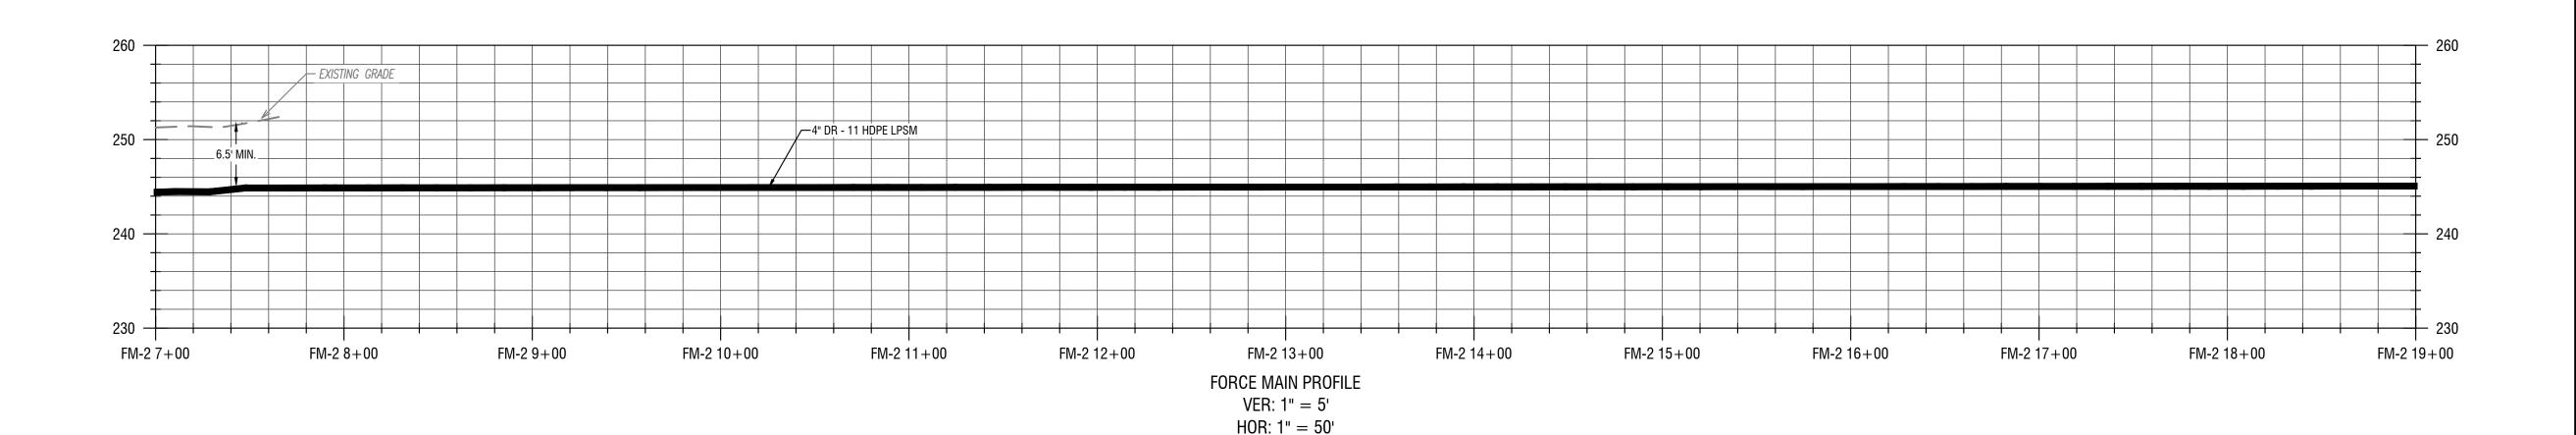

LOW PRESSURE SEWER PROFILE

C311 VERT: 1' = 5' HORIZ: 1' = 50'


KEY NOTES

- 1 GRINDER PUMPS WITH REMOTE VENTING
- 2 INSTALL ALARM PANEL (FURNISHED BY OWNER), MOUNTED TO HOUSE
- (3) INSTALL ALARM PANEL (FURNISHED BY OWNER), MOUNTED TO POST
- PROVIDE ONE  $\frac{3}{4}$ , PVC CONDUIT BETWEEN THE PUMP CONTROL / ALARM PANEL & THE GRINDER PUMP. INSTALL ELECTRICAL SUPPLY CABLE (ESC) PROVIDED WITH PUMP - CONNECT TO GRINDER PUMP AND CONTROL / ALARM PANEL.

Powered by partnership.

300 State Street, Suite 201 Rochester, NY 14614 585-454-6110


labellapc.com

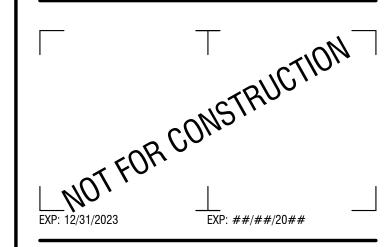

CERTIFICATE OF AUTHORIZATION NUMBER: PROFESSIONAL ENGINEERING: 095099 LAND SURVEYING: 017976 GEOLOGICAL: 018750

It is a violation of New York Education Law Art. 145 Sec. 7209 & Art. 147 Sec. 7307, for any person, unless acting under the direction of a licensed architect, professional engineer, or land surveyor, to alter an item in any way. If an item bearing the seal of an architect, engineer, or land surveyor is altered; the altering architect, engineer, or land surveyor shall affix to the item their seal and notation "altered by" followed by their signature and date of such alteration, and a specific description of the alteration.

© 2023 LaBella Associates

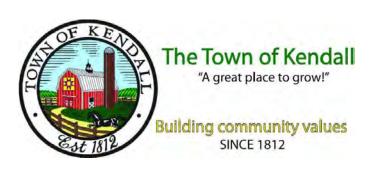

#### **REDI WASTEWATER** INFRASTRUCTURE (CONTRACT 1)

TOWN OF KENDALL & TOWN OF HAMLIN

NO:	DATE:	DESCRIPTION:	
Revisions			
PROJECT I	NUMBER:	2200455	
		2200403	
DRAWN B	Y:		
REVIEWED	) DV:	JCB	
DEVIEWED	, рт.	JRE	

ISSUED FOR: 60% DESIGN SUBMISSION

DATE: SEPTEMBER 2023

DRAWING NAME:

# LOW PRESSURE SEWER PLAN & PROFILES (LAKE ONTARIO STATE PKWY)

\_\_ EXISTING GRADE EXISTING STORM— —EXISTING STORM EXISTING STORM— 4" DR - 11 HDPE LPSM 6.5' MIN. 250 <sup>-</sup>18" MIN. (TYP) - 240 FM-219+00FM-220+00FM-221+00FM-222+00FM-223+00FM-2 24+00 FM-225+00FM-226+00FM-227+00FM-228+00FM-229+00FM-230+00FORCE MAIN PROFILE VER: 1'' = 5'HOR: 1" = 50"

> LOW PRESSURE SEWER PROFILE C312 VERT: 1' = 5' HORIZ: 1' = 50'


C312 HORIZ: 1' = 50'

KEY NOTES

- 1 GRINDER PUMPS WITH REMOTE VENTING
- 2 INSTALL ALARM PANEL (FURNISHED BY OWNER), MOUNTED TO HOUSE
- install alarm panel (furnished by owner), mounted to post
- PROVIDE ONE  $\frac{3}{4}$ ", PVC CONDUIT BETWEEN THE PUMP CONTROL / ALARM PANEL & THE GRINDER PUMP. INSTALL ELECTRICAL SUPPLY CABLE (ESC) PROVIDED WITH PUMP - CONNECT TO GRINDER PUMP AND CONTROL / ALARM

300 State Street, Suite 201 Rochester, NY 14614 585-454-6110


labellapc.com

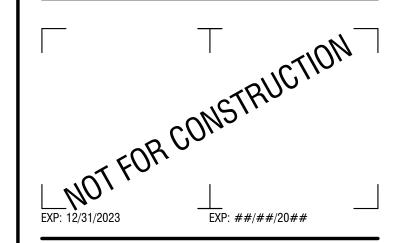

CERTIFICATE OF AUTHORIZATION NUMBER: PROFESSIONAL ENGINEERING: 095099 LAND SURVEYING: 017976 GEOLOGICAL: 018750

It is a violation of New York Education Law Art. 145 Sec. 7209 & Art. 147 Sec. 7307, for any person, unless acting under the direction of a licensed architect, professional engineer, or land surveyor, to alter an item in any way. If an item bearing the seal of an architect, engineer, or land surveyor is altered; the altering architect, engineer, or land surveyor shall affix to the item their seal and notation "altered by" followed by their signature and date of such alteration, and a specific description of the alteration.

© 2023 LaBella Associates

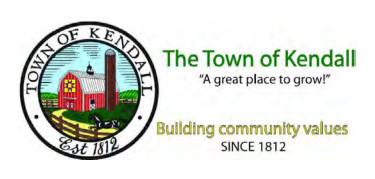


### **REDI WASTEWATER INFRASTRUCTURE** (CONTRACT 1)

TOWN OF KENDALL & TOWN OF HAMLIN

PROJECT NUMBER DRAWN BY:		
PROJECT NUMBER		
DRAWN BY:	2200455	
	IOD	
REVIEWED BY:	JCB	
	JRE	
ISSUED FOR:	60% DESIGN SUBMISSION	
DATE:		
DRAWING NAME:	SEPTEMBER 2023	

# LOW PRESSURE SEWER PLAN & PROFILES (LAKE ONTARIO STATE PKWY)

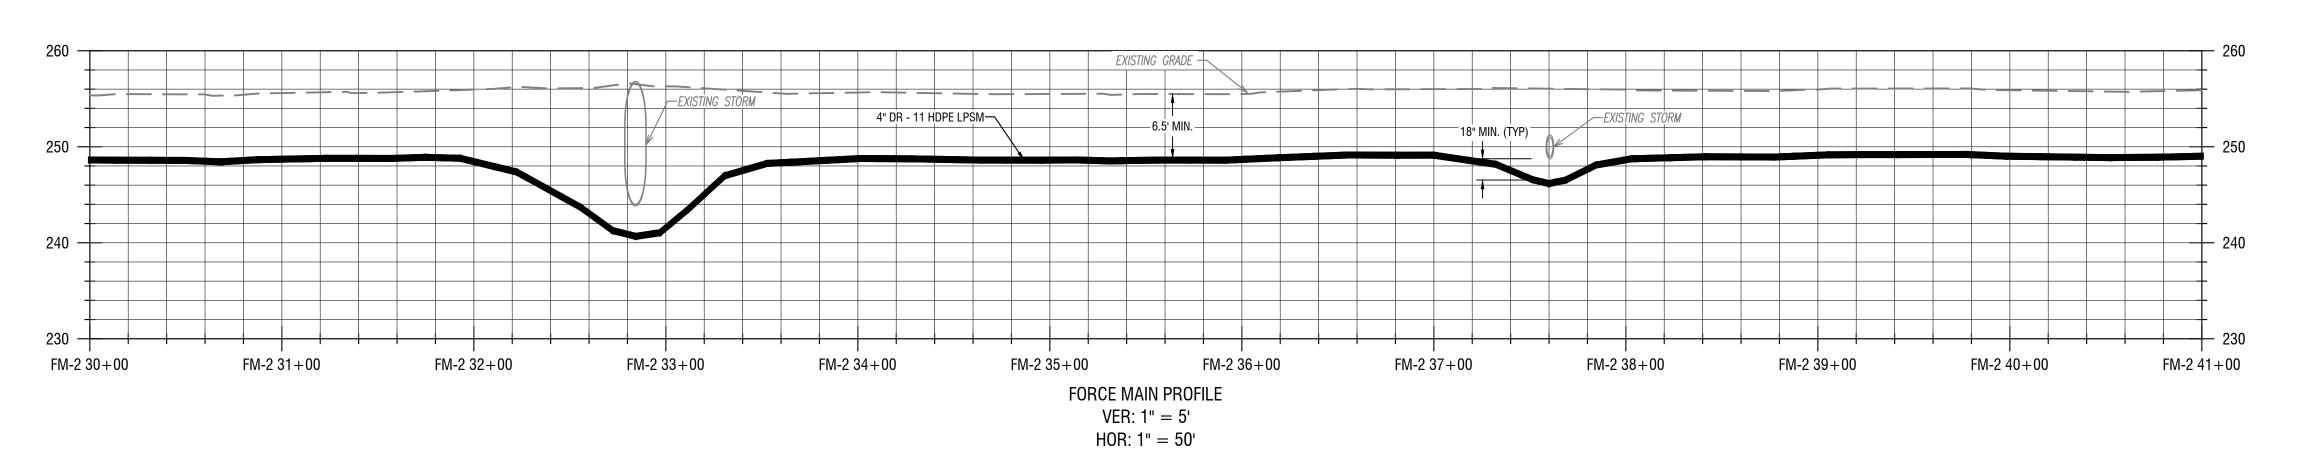

LOW PRESSURE SEWER PROFILE C313 VERT: 1' = 5' HORIZ: 1' = 50'

C313  $\int$  HORIZ: 1' = 50'


KEY NOTES

SCALE: 1" = 50'

- 1 GRINDER PUMPS WITH REMOTE VENTING
- 2 INSTALL ALARM PANEL (FURNISHED BY OWNER), MOUNTED TO HOUSE
- 3 INSTALL ALARM PANEL (FURNISHED BY OWNER), MOUNTED TO POST
- PROVIDE ONE  $\frac{3}{4}$ ", PVC CONDUIT BETWEEN THE PUMP CONTROL / ALARM PANEL & THE GRINDER PUMP. INSTALL ELECTRICAL SUPPLY CABLE (ESC) PROVIDED WITH PUMP - CONNECT TO GRINDER PUMP AND CONTROL / ALARM PANEL.

300 State Street, Suite 201 Rochester, NY 14614 585-454-6110


labellapc.com

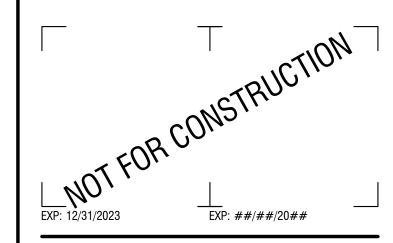

CERTIFICATE OF AUTHORIZATION NUMBER: PROFESSIONAL ENGINEERING: 095099 LAND SURVEYING: 017976 GEOLOGICAL: 018750

It is a violation of New York Education Law Art. 145 Sec. 7209 & Art. 147 Sec. 7307, for any person, unless acting under the direction of a licensed architect, professional engineer, or land surveyor, to alter an item in any way. If an item bearing the seal of an architect, engineer, or land surveyor is altered; the altering architect, engineer, or land surveyor shall affix to the item their seal and notation "altered by" followed by their signature and date of such alteration, and a specific description of the alteration.

© 2023 LaBella Associates

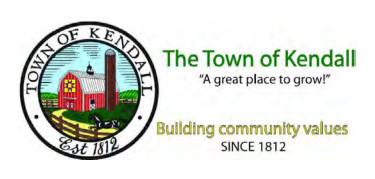

### **REDI WASTEWATER INFRASTRUCTURE** (CONTRACT 1)

TOWN OF KENDALL & TOWN OF HAMLIN

NO:	DATE:	DESCRIPTION:
Revisions		
PROJECT N	NUMBER:	2200455
DRAWN BY	/:	
DEVIEWED DV	D) (	JCB
REVIEWED BY:		JRE
ISSUED FO		


60% DESIGN SUBMISSION


DATE: SEPTEMBER 2023

DRAWING NAME:

# LOW PRESSURE SEWER PLAN & PROFILES (LAKE ONTARIO STATE PKWY)

LOW PRESSURE SEWER PLAN C314  $\sqrt{\text{HORIZ: 1'}} = 50'$ 

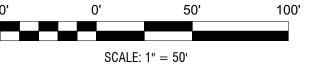

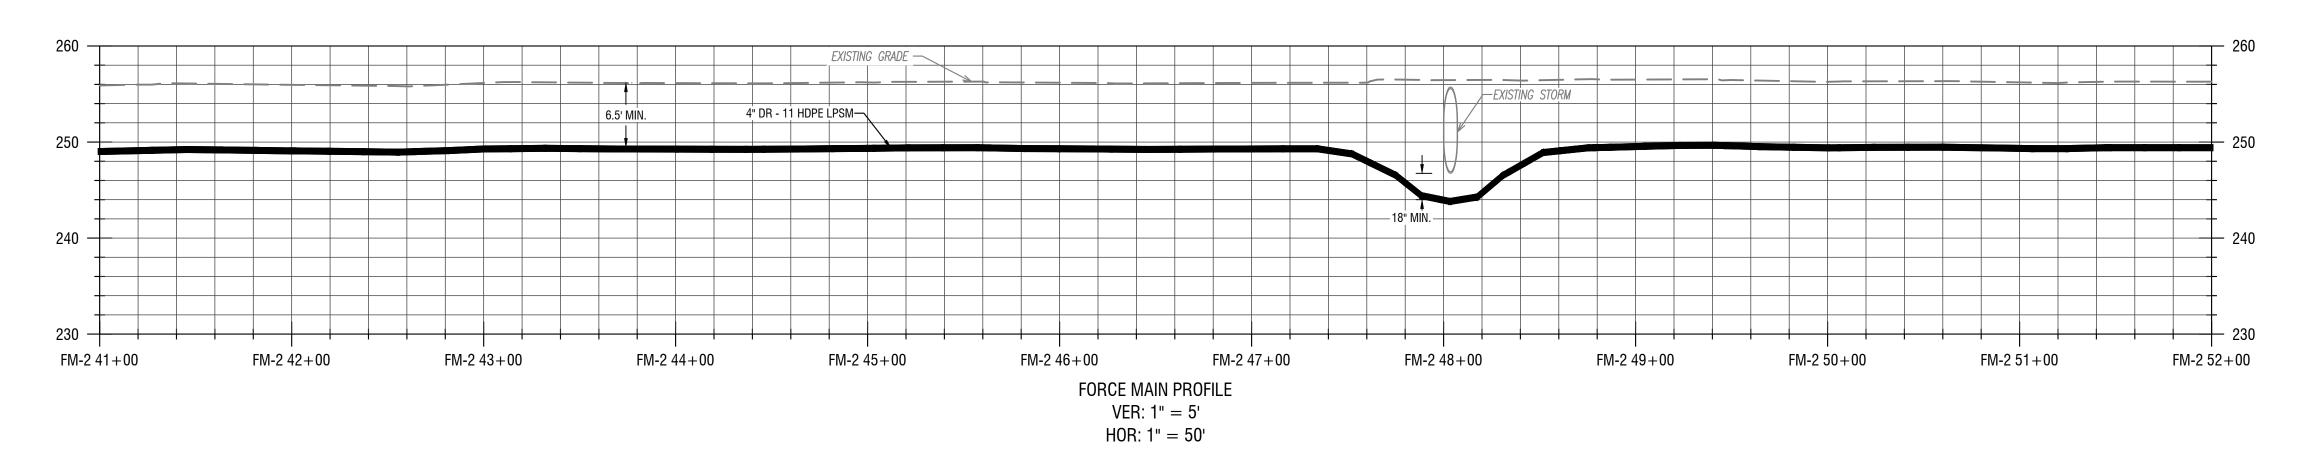


LOW PRESSURE SEWER PROFILE C314 VERT: 1' = 5' HORIZ: 1' = 50'

KEY NOTES

- 1 GRINDER PUMPS WITH REMOTE VENTING
- 2 INSTALL ALARM PANEL (FURNISHED BY OWNER), MOUNTED TO HOUSE
- install alarm panel (furnished by owner), mounted to post
- PROVIDE ONE  $\frac{3}{4}$ , PVC CONDUIT BETWEEN THE PUMP CONTROL / ALARM PANEL & THE GRINDER PUMP. INSTALL ELECTRICAL SUPPLY CABLE (ESC) PROVIDED WITH PUMP - CONNECT TO GRINDER PUMP AND CONTROL / ALARM PANEL.

300 State Street, Suite 201 Rochester, NY 14614 585-454-6110


labellapc.com

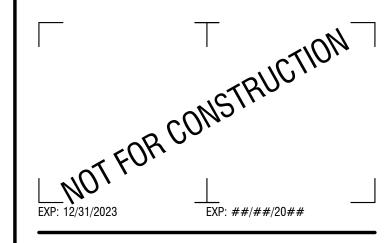

CERTIFICATE OF AUTHORIZATION NUMBER: PROFESSIONAL ENGINEERING: 095099 LAND SURVEYING: 017976 GEOLOGICAL: 018750

It is a violation of New York Education Law Art. 145 Sec. 7209 & Art. 147 Sec. 7307, for any person, unless acting under the direction of a licensed architect, professional engineer, or land surveyor, to alter an item in any way. If an item bearing the seal of an architect, engineer, or land surveyor is altered; the altering architect, engineer, or land surveyor shall affix to the item their seal and notation "altered by" followed by their signature and date of such alteration, and a specific description of the alteration.

© 2023 LaBella Associates

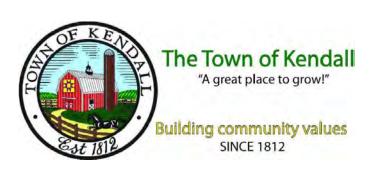

# **REDI WASTEWATER INFRASTRUCTURE** (CONTRACT 1)

TOWN OF KENDALL & TOWN OF HAMLIN

NO:	DATE:	DESCRIPTION:
Revisions		
PROJECT	NUMBER:	2200455

DRAWN BY: JCB REVIEWED BY: JRE ISSUED FOR:


60% DESIGN SUBMISSION DATE:

SEPTEMBER 2023

DRAWING NAME:

# LOW PRESSURE SEWER PLAN & PROFILES (LAKE ONTARIO STATE PKWY)

LOW PRESSURE SEWER PLAN SCALE: 1" = 50' C315 HORIZ: 1' = 50'

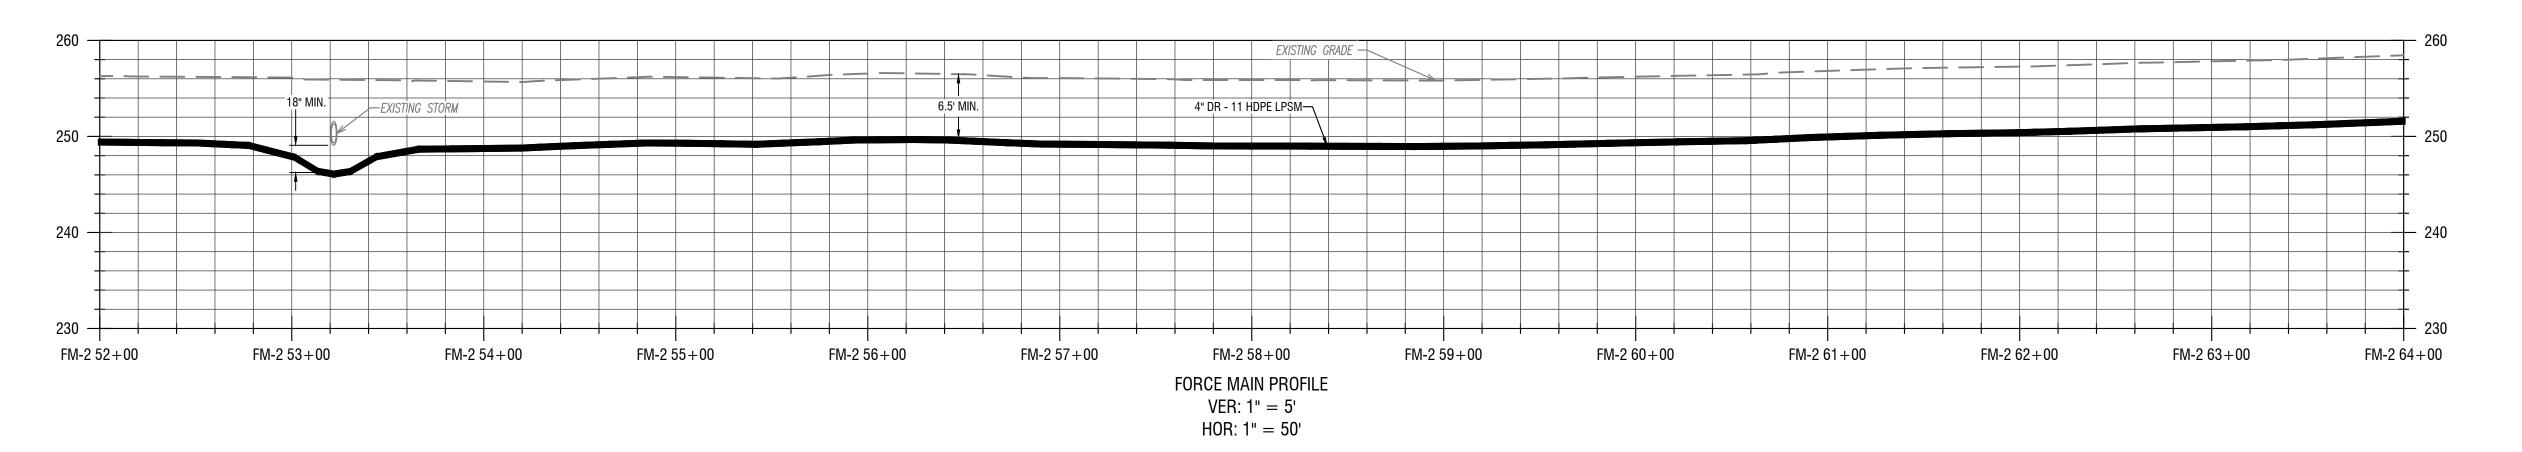


LOW PRESSURE SEWER PROFILE C315 VERT: 1' = 5' HORIZ: 1' = 50'

KEY NOTES

- 1 GRINDER PUMPS WITH REMOTE VENTING
- 2 INSTALL ALARM PANEL (FURNISHED BY OWNER), MOUNTED TO HOUSE
- INSTALL ALARM PANEL (FURNISHED BY OWNER), MOUNTED TO POST
- PROVIDE ONE  $\frac{3}{4}$ ", PVC CONDUIT BETWEEN THE PUMP CONTROL / ALARM PANEL & THE GRINDER PUMP. INSTALL ELECTRICAL SUPPLY CABLE (ESC) PROVIDED WITH PUMP - CONNECT TO GRINDER PUMP AND CONTROL / ALARM PANEL.

300 State Street, Suite 201 Rochester, NY 14614 585-454-6110

labellapc.com

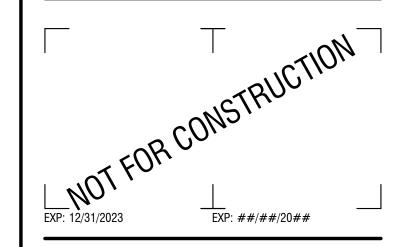

CERTIFICATE OF AUTHORIZATION NUMBER: PROFESSIONAL ENGINEERING: 095099 LAND SURVEYING: 017976 GEOLOGICAL: 018750

It is a violation of New York Education Law Art. 145 Sec. 7209 & Art. 147 Sec. 7307, for any person, unless acting under the direction of a licensed architect, professional engineer, or land surveyor, to alter an item in any way. If an item bearing the seal of an architect, engineer, or land surveyor is altered; the altering architect, engineer, or land surveyor shall affix to the item their seal and notation "altered by" followed by their signature and date of such alteration, and a specific description of the alteration.

© 2023 LaBella Associates



# **REDI WASTEWATER INFRASTRUCTURE** (CONTRACT 1)

TOWN OF KENDALL & TOWN OF HAMLIN


DESCRIPTION:

Revisions			
PROJECT NUMB			
	2200455		
DRAWN BY:	IOD		
REVIEWED BY:	JCB		
	JRE		
ISSUED FOR:	60% DESIGN SUBMISSION		
DATE:	SEPTEMBER 2023		

DRAWING NAME:

NO: DATE:

# LOW PRESSURE SEWER PLAN & PROFILES (LAKE ONTARIO STATE PKWY)

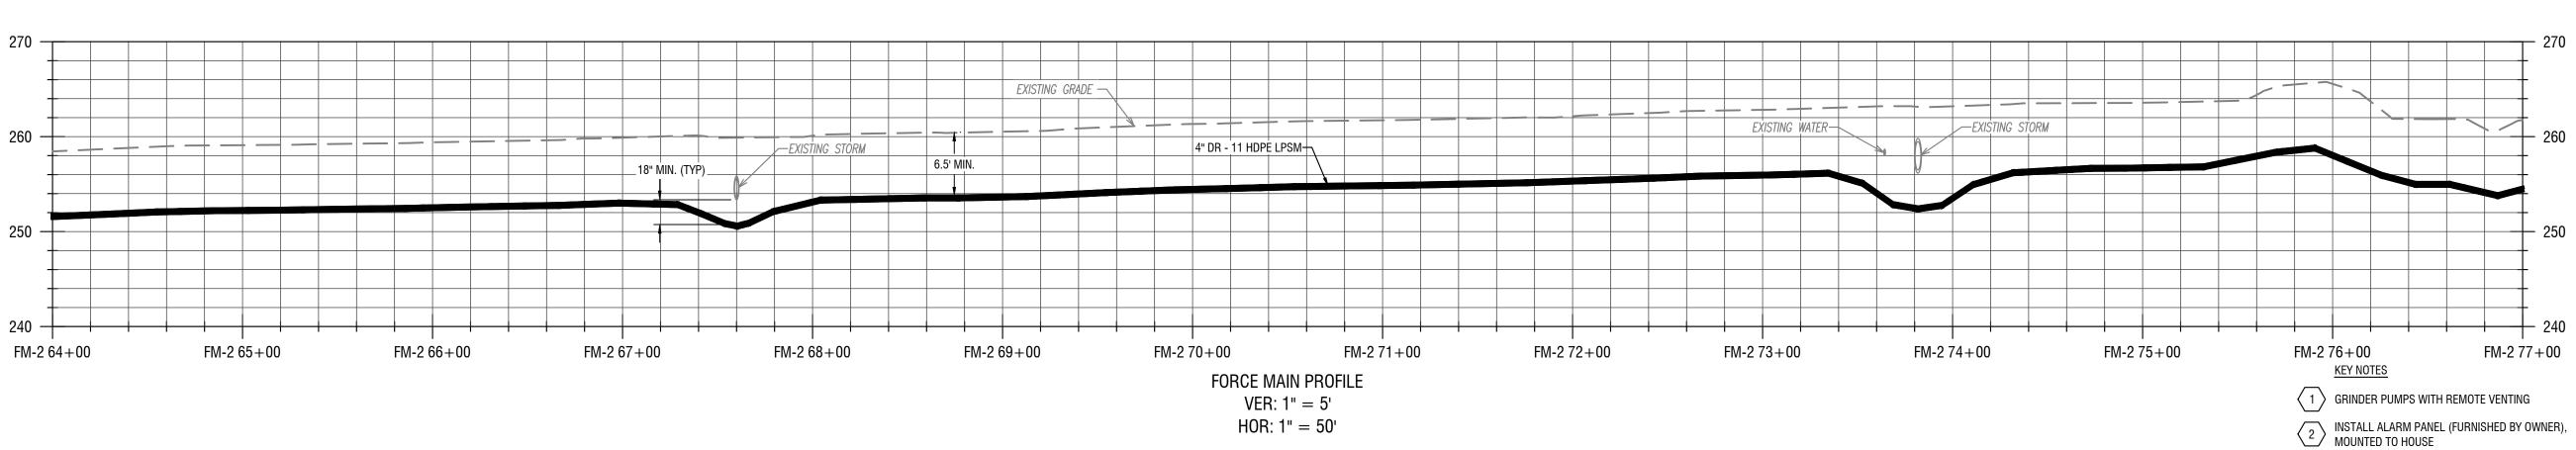

LOW PRESSURE SEWER PROFILE

C316 VERT: 1' = 5' HORIZ: 1' = 50' INSTALL ALARM PANEL (FURNISHED BY OWNER),
MOUNTED TO POST


PROVIDE ONE 3/4", PVC CONDUIT BETWEEN THE
PUMP CONTROL / ALARM PANEL & THE
GRINDER PUMP. INSTALL ELECTRICAL SUPPLY
CABLE (ESC) PROVIDED WITH PUMP - CONNECT
TO GRINDER PUMP AND CONTROL / ALARM

PANEL.

LaBella
Powered by partnership.

300 State Street, Suite 201 Rochester, NY 14614 585-454-6110

labellapc.com

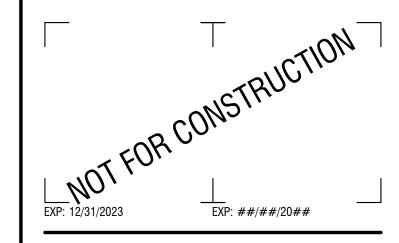

CERTIFICATE OF AUTHORIZATION NUMBER: PROFESSIONAL ENGINEERING: 095099 LAND SURVEYING: 017976 GEOLOGICAL: 018750

It is a violation of New York Education Law Art. 145 Sec. 7209 & Art. 147 Sec. 7307, for any person, unless acting under the direction of a licensed architect, professional engineer, or land surveyor, to alter an item in any way. If an item bearing the seal of an architect, engineer, or land surveyor is altered; the altering architect, engineer, or land surveyor shall affix to the item their seal and notation "altered by" followed by their signature and date of such alteration, and a specific description of the alteration.

© 2023 LaBella Associates



# REDI WASTEWATER INFRASTRUCTURE (CONTRACT 1)

TOWN OF KENDALL & TOWN OF HAMLIN

NO:	DATE:	DESCRIPTION:
Revisions		
PROJECT	NUMBER:	0000455
		2200455

DRAWN BY:

JCB

REVIEWED BY:

JRE

ISSUED FOR:

60% DESIGN SUBMISSION

DATE:

DRAWING NAME:


# LOW PRESSURE SEWER PLAN & PROFILES (LAKE ONTARIO STATE PKWY)

SEPTEMBER 2023

DRAWING NUMBER:

LOW PRESSURE SEWER PLAN C317 HORIZ: 1' = 50'

SCALE: 1" = 50'

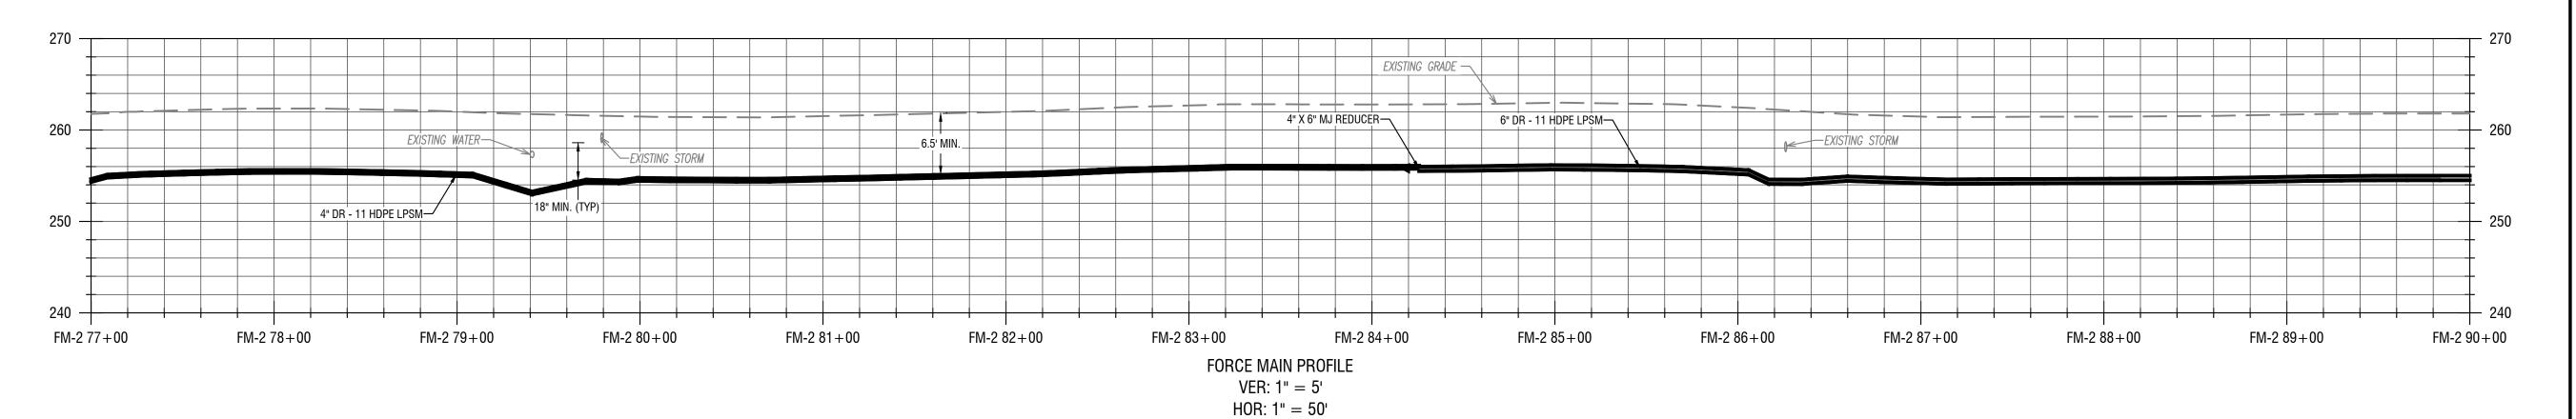

LOW PRESSURE SEWER PROFILE C317


VERT: 1' = 5' HORIZ: 1' = 50'

KEY NOTES 1 GRINDER PUMPS WITH REMOTE VENTING

- 2 INSTALL ALARM PANEL (FURNISHED BY OWNER), MOUNTED TO HOUSE
- install alarm panel (furnished by owner), mounted to post
- PROVIDE ONE  $\frac{3}{4}$ ", PVC CONDUIT BETWEEN THE PUMP CONTROL / ALARM PANEL & THE GRINDER PUMP. INSTALL ELECTRICAL SUPPLY CABLE (ESC) PROVIDED WITH PUMP - CONNECT TO GRINDER PUMP AND CONTROL / ALARM PANEL.

300 State Street, Suite 201 Rochester, NY 14614 585-454-6110


labellapc.com

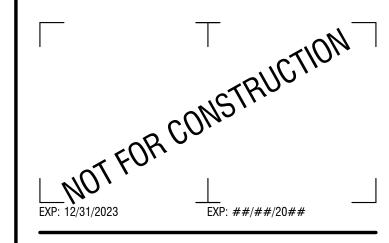

CERTIFICATE OF AUTHORIZATION NUMBER: PROFESSIONAL ENGINEERING: 095099 LAND SURVEYING: 017976 GEOLOGICAL: 018750

It is a violation of New York Education Law Art. 145 Sec. 7209 & Art. 147 Sec. 7307, for any person, unless acting under the direction of a licensed architect, professional engineer, or land surveyor, to alter an item in any way. If an item bearing the seal of an architect, engineer, or land surveyor is altered; the altering architect, engineer, or land surveyor shall affix to the item their seal and notation "altered by" followed by their signature and date of such alteration, and a specific description of the alteration.

© 2023 LaBella Associates

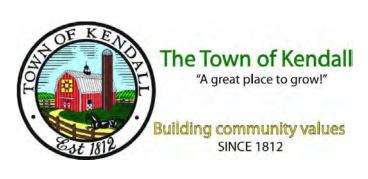


### **REDI WASTEWATER INFRASTRUCTURE** (CONTRACT 1)

TOWN OF KENDALL & TOWN OF HAMLIN

NO:	DATE:	DESCRIPTION:
Revisions		
PROJECT N	NUMBER:	2200455
DRAWN BY	<b>/</b> :	
DEMENVED	DV∙	JCB
REVIEWED BY:	Dī.	JRE
ISSUED FO		DECION CURMICCION
	60%	DESIGN SUBMISSION
DATE:		VEDTEMBED 0000
	5	SEPTEMBER 2023
DRAWING	NAME:	

# LOW PRESSURE SEWER PLAN & PROFILES (BANNER BEACH RD)

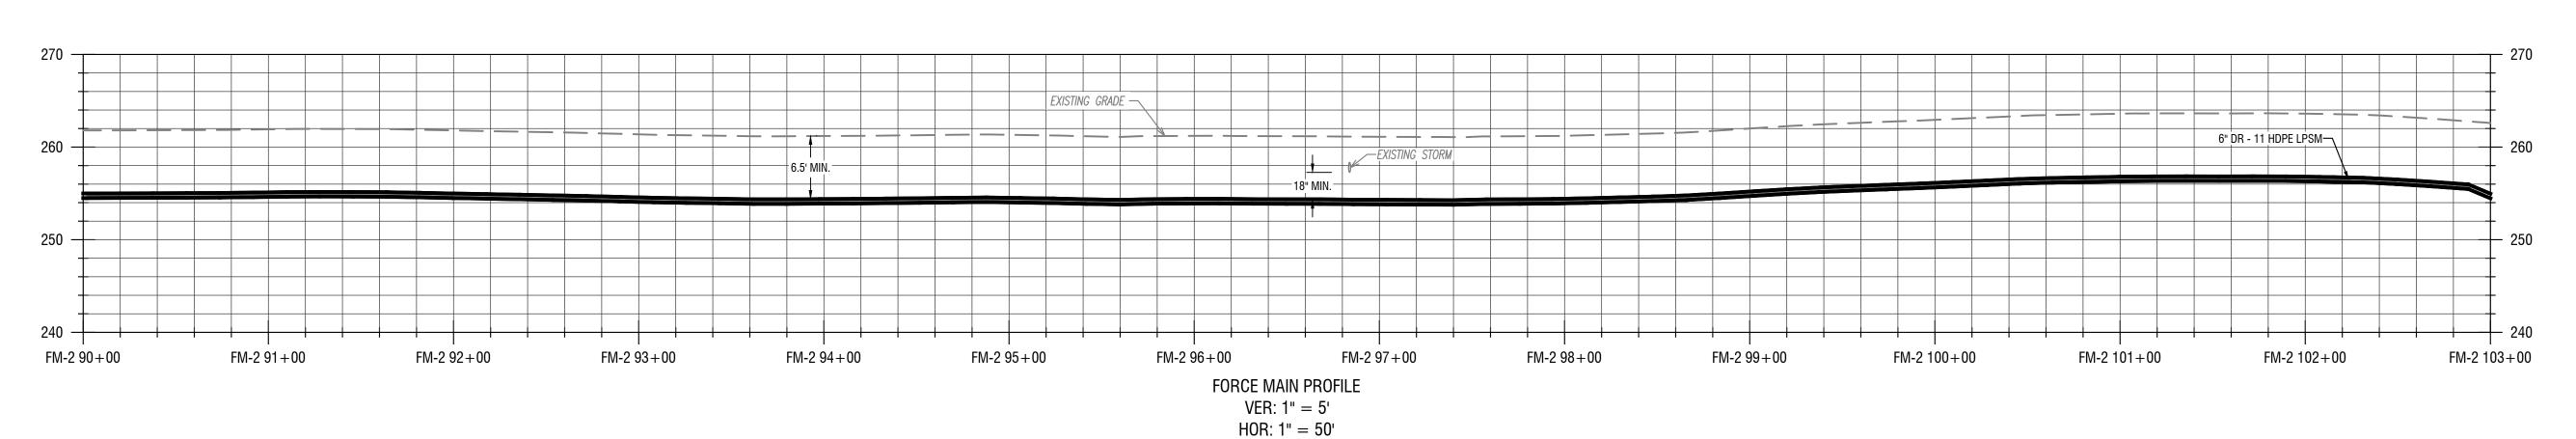

LOW PRESSURE SEWER PROFILE C318 VERT: 1' = 5' HORIZ: 1' = 50'

C318 HORIZ: 1' = 50'


KEY NOTES

- 1 GRINDER PUMPS WITH REMOTE VENTING
- 2 INSTALL ALARM PANEL (FURNISHED BY OWNER), MOUNTED TO HOUSE
- 3 INSTALL ALARM PANEL (FURNISHED BY OWNER), MOUNTED TO POST

PROVIDE ONE  $\frac{3}{4}$ ", PVC CONDUIT BETWEEN THE PUMP CONTROL / ALARM PANEL & THE GRINDER PUMP. INSTALL ELECTRICAL SUPPLY CABLE (ESC) PROVIDED WITH PUMP - CONNECT TO GRINDER PUMP AND CONTROL / ALARM PANEL.

300 State Street, Suite 201 Rochester, NY 14614 585-454-6110


labellapc.com

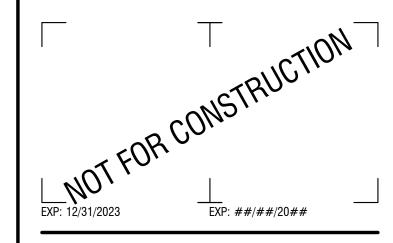

CERTIFICATE OF AUTHORIZATION NUMBER: PROFESSIONAL ENGINEERING: 095099 LAND SURVEYING: 017976 GEOLOGICAL: 018750

It is a violation of New York Education Law Art. 145 Sec. 7209 & Art. 147 Sec. 7307, for any person, unless acting under the direction of a licensed architect, professional engineer, or land surveyor, to alter an item in any way. If an item bearing the seal of an architect, engineer, or land surveyor is altered; the altering architect, engineer, or land surveyor shall affix to the item their seal and notation "altered by" followed by their signature and date of such alteration, and a specific description of the alteration.

© 2023 LaBella Associates

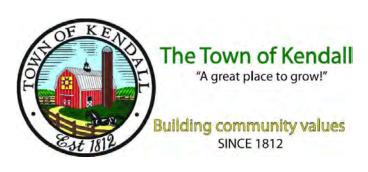


### **REDI WASTEWATER INFRASTRUCTURE** (CONTRACT 1)

TOWN OF KENDALL & TOWN OF HAMLIN

NO:	DATE:	DESCRIPTION:
Revisions		
PROJECT N	IUMBER:	2200455
DRAWN BY	<b>'</b> :	
REVIEWED	RV·	JCB
TILVILVVLD DI.	<b>5</b> 1.	JRE
ISSUED FO		DESIGN SUBMISSION
DATE:	S	EPTEMBER 2023

# LOW PRESSURE SEWER PLAN & PROFILES (BANNER BEACH RD)

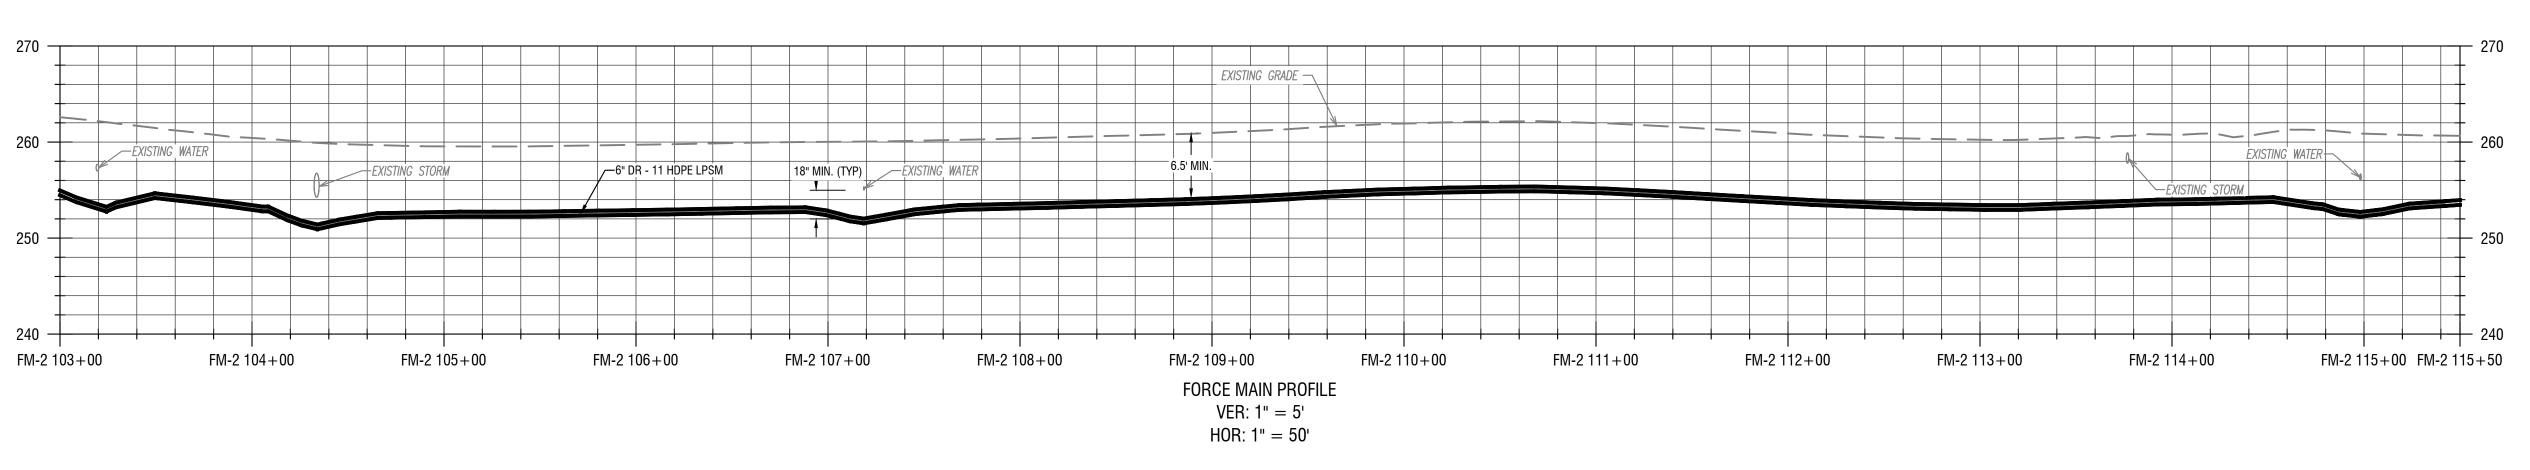

LOW PRESSURE SEWER PROFILE C319 VERT: 1' = 5' HORIZ: 1' = 50'

C319 HORIZ: 1' = 50'

KEY NOTES

SCALE: 1" = 50'

1 GRINDER PUMPS WITH REMOTE VENTING

2 INSTALL ALARM PANEL (FURNISHED BY OWNER), MOUNTED TO HOUSE


(3) INSTALL ALARM PANEL (FURNISHED BY OWNER), MOUNTED TO POST

PROVIDE ONE  $\frac{3}{4}$ ", PVC CONDUIT BETWEEN THE PUMP CONTROL / ALARM PANEL & THE GRINDER PUMP. INSTALL ELECTRICAL SUPPLY CABLE (ESC) PROVIDED WITH PUMP - CONNECT TO GRINDER PUMP AND CONTROL / ALARM PANEL.

Powered by partnership.

300 State Street, Suite 201 Rochester, NY 14614 585-454-6110

labellapc.com

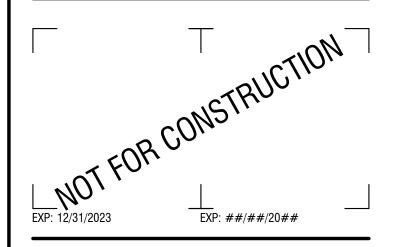

CERTIFICATE OF AUTHORIZATION NUMBER: PROFESSIONAL ENGINEERING: 095099 LAND SURVEYING: 017976 GEOLOGICAL: 018750

It is a violation of New York Education Law Art. 145 Sec. 7209 & Art. 147 Sec. 7307, for any person, unless acting under the direction of a licensed architect, professional engineer, or land surveyor, to alter an item in any way. If an item bearing the seal of an architect, engineer, or land surveyor is altered; the altering architect, engineer, or land surveyor shall affix to the item their seal and notation "altered by" followed by their signature and date of such alteration, and a specific description of the alteration.

© 2023 LaBella Associates



# **REDI WASTEWATER INFRASTRUCTURE** (CONTRACT 1)


TOWN OF KENDALL & TOWN OF HAMLIN

NO:	DATE:	DESCRIPTION:
Revisions		
PROJECT NUM	BER:	2200455
DRAWN BY:		
REVIEWED BY:		JCB
NEVIEWED DI.		JRE
ISSUED FOR:	CO0/ I	
	6U% I	DESIGN SUBMISSION
DATE:	c	EPTEMBER 2023
	3	EF I EIVIDEN 2023

# LOW PRESSURE SEWER PLAN & PROFILES (BANNER BEACH RD)

DRAWING NUMBER:

DRAWING NAME:

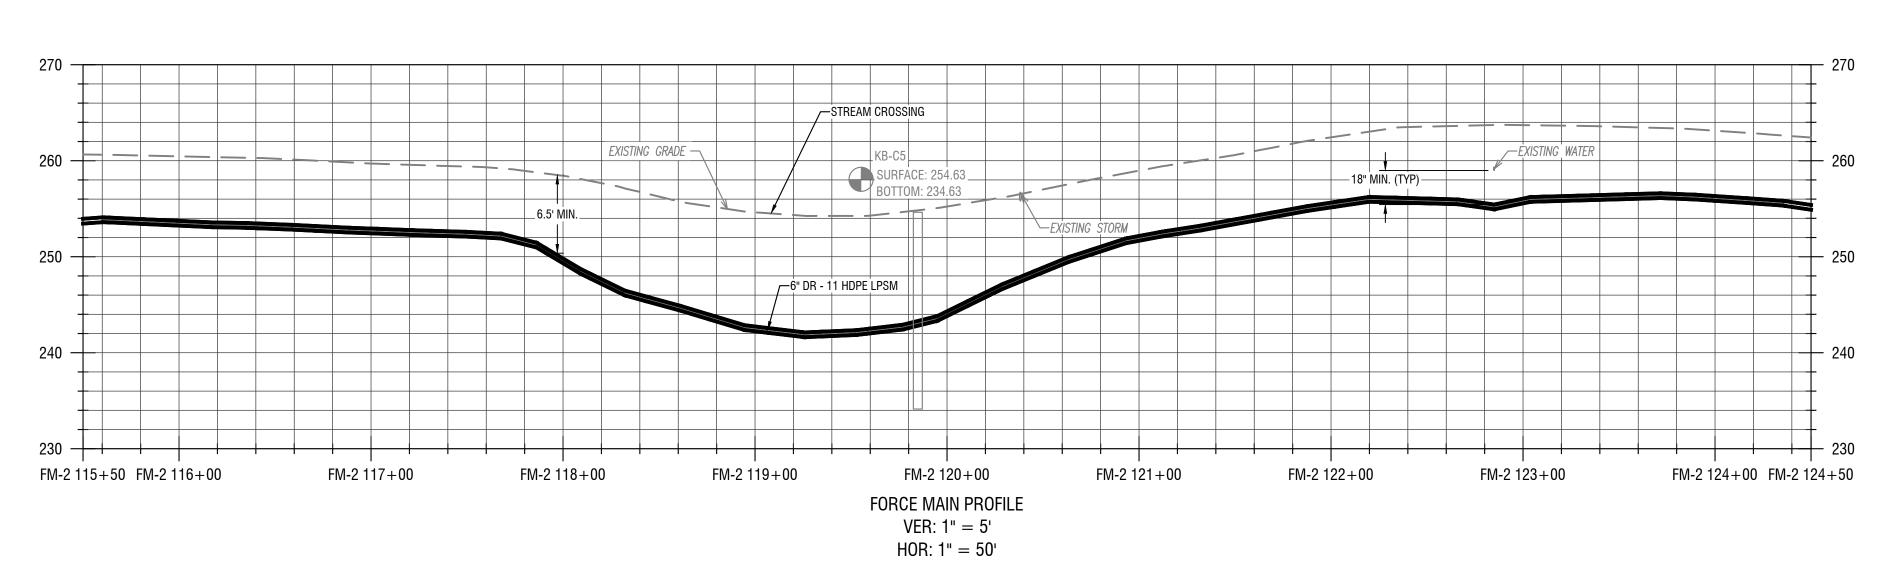


2 LOW PRESSURE SEWER PROFILE

C320 VERT: 1' = 5'
HORIZ: 1' = 50'

LaBella
Powered by partnership.

300 State Street, Suite 201 Rochester, NY 14614 585-454-6110

labellapc.com

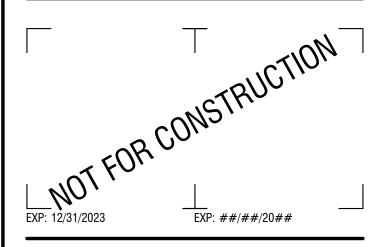

CERTIFICATE OF AUTHORIZATION NUMBER: PROFESSIONAL ENGINEERING: 095099 LAND SURVEYING: 017976 GEOLOGICAL: 018750

It is a violation of New York Education Law Art. 145 Sec. 7209 & Art. 147 Sec. 7307, for any person, unless acting under the direction of a licensed architect, professional engineer, or land surveyor, to alter an item in any way. If an item bearing the seal of an architect, engineer, or land surveyor is altered; the altering architect, engineer, or land surveyor shall affix to the item their seal and notation "altered by" followed by their signature and date of such alteration, and a specific description of the alteration.

© 2023 LaBella Associates



### REDI WASTEWATER INFRASTRUCTURE (CONTRACT 1)

TOWN OF KENDALL & TOWN OF HAMLIN

DATE:	DESCRIPTION:		
NUMBER:	2200455		
/ <u>:</u>			
	JCB		
BY:	JRE		
R: <b>60</b> %	DESIGN SUBMISSION		
	SEPTEMBER 2023		
	NUMBER:  /: BY: R: 60%		

# LOW PRESSURE SEWER PLAN & PROFILES (LAKELAND BEACH RD)

DRAWING NUMBER:

KEY NOTES

PANEL.


1 GRINDER PUMPS WITH REMOTE VENTING

2 INSTALL ALARM PANEL (FURNISHED BY OWNER), MOUNTED TO HOUSE

INSTALL ALARM PANEL (FURNISHED BY OWNER), MOUNTED TO POST

GRINDER PUMP. INSTALL ELECTRICAL SUPPLY CABLE (ESC) PROVIDED WITH PUMP - CONNECT TO GRINDER PUMP AND CONTROL / ALARM

PROVIDE ONE  $\frac{3}{4}$ , PVC CONDUIT BETWEEN THE PUMP CONTROL / ALARM PANEL & THE

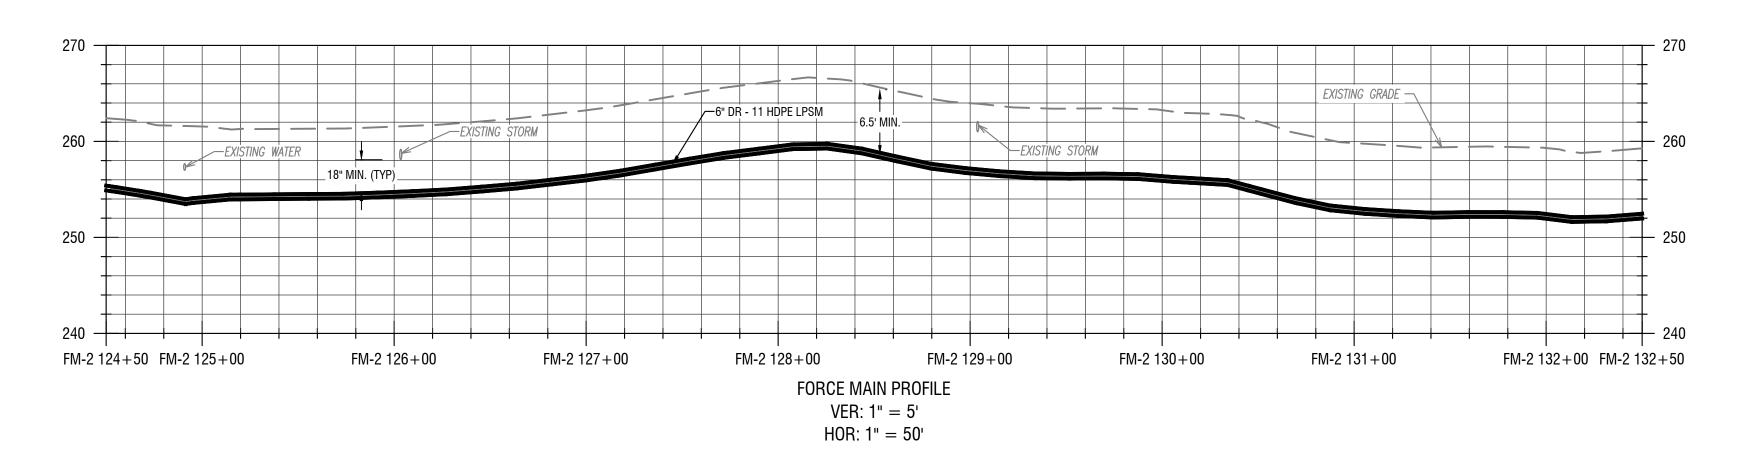

LOW PRESSURE SEWER PROFILE

C321 VERT: 1' = 5' HORIZ: 1' = 50'


KEY NOTES

- 1 GRINDER PUMPS WITH REMOTE VENTING
- 2 INSTALL ALARM PANEL (FURNISHED BY OWNER), MOUNTED TO HOUSE
- install alarm panel (furnished by owner), mounted to post
- PROVIDE ONE  $\frac{3}{4}$ ", PVC CONDUIT BETWEEN THE PUMP CONTROL / ALARM PANEL & THE GRINDER PUMP. INSTALL ELECTRICAL SUPPLY CABLE (ESC) PROVIDED WITH PUMP - CONNECT TO GRINDER PUMP AND CONTROL / ALARM PANEL.

Powered by partnership.

300 State Street, Suite 201 Rochester, NY 14614 585-454-6110


labellapc.com

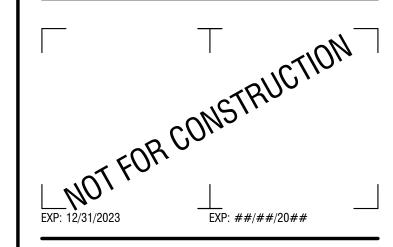

CERTIFICATE OF AUTHORIZATION NUMBER: PROFESSIONAL ENGINEERING: 095099 LAND SURVEYING: 017976 GEOLOGICAL: 018750

It is a violation of New York Education Law Art. 145 Sec. 7209 & Art. 147 Sec. 7307, for any person, unless acting under the direction of a licensed architect, professional engineer, or land surveyor, to alter an item in any way. If an item bearing the seal of an architect, engineer, or land surveyor is altered; the altering architect, engineer, or land surveyor shall affix to the item their seal and notation "altered by" followed by their signature and date of such alteration, and a specific description of the alteration.

© 2023 LaBella Associates

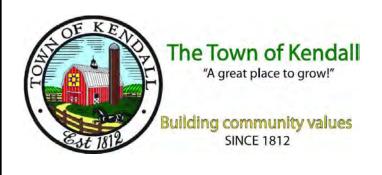

#### **REDI WASTEWATER INFRASTRUCTURE** (CONTRACT 1)

TOWN OF KENDALL & TOWN OF HAMLIN


NO:	DATE:	DESCRIPTION:
Revisions		
PROJECT N	NUMBER:	2200455
DRAWN BY	<b>/</b> :	IOD
REVIEWED	RV∙	JCB
TILVILVVLD DI.	<b>5</b> 1.	JRE
ISSUED FO		DESIGN SUBMISSION
DATE:	S	EPTEMBER 2023


# LOW PRESSURE SEWER PLAN & PROFILES (LAKELAND BEACH RD)

DRAWING NUMBER:

DRAWING NAME:

LOW PRESSURE SEWER PLAN C322 HORIZ: 1' = 50'

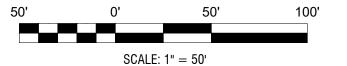

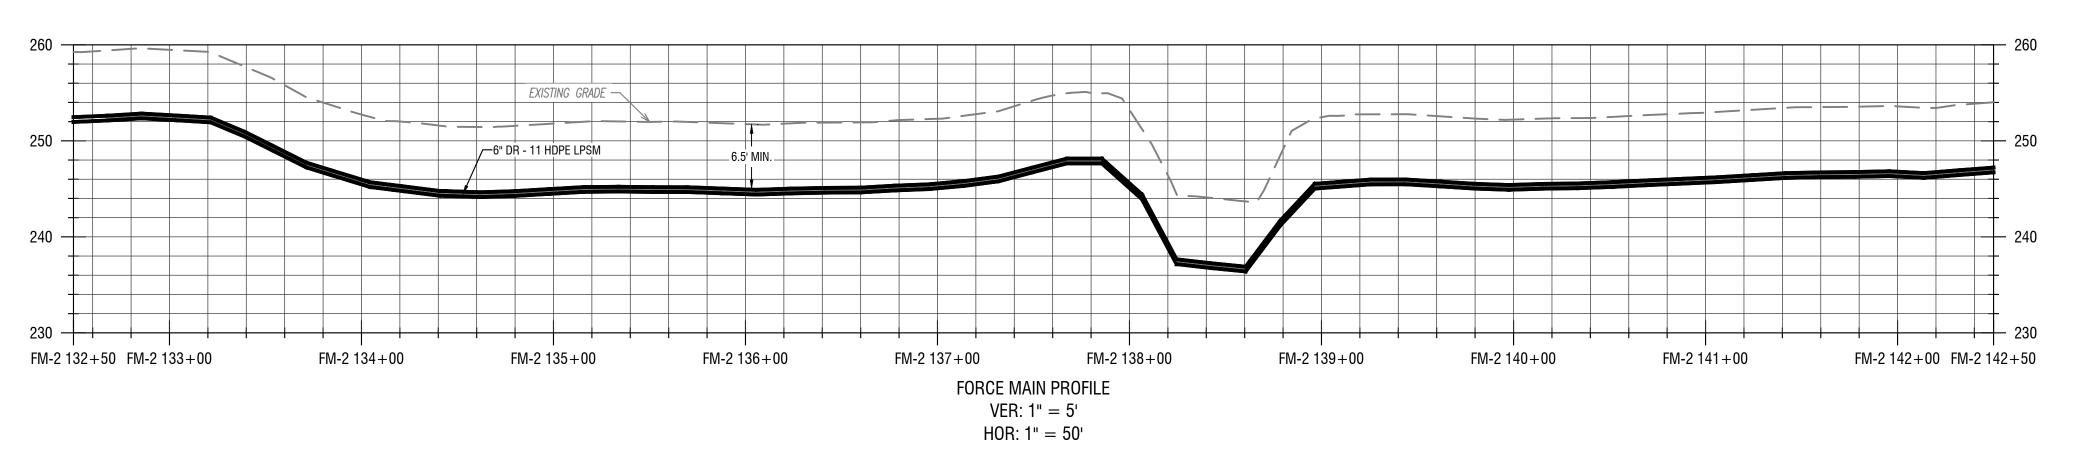

LOW PRESSURE SEWER PROFILE

C322 VERT: 1' = 5' HORIZ: 1' = 50'


KEY NOTES

PANEL.

- 1 GRINDER PUMPS WITH REMOTE VENTING
- 2 INSTALL ALARM PANEL (FURNISHED BY OWNER), MOUNTED TO HOUSE
- (3) INSTALL ALARM PANEL (FURNISHED BY OWNER), MOUNTED TO POST
- PROVIDE ONE  $\frac{3}{4}$ ", PVC CONDUIT BETWEEN THE PUMP CONTROL / ALARM PANEL & THE GRINDER PUMP. INSTALL ELECTRICAL SUPPLY CABLE (ESC) PROVIDED WITH PUMP - CONNECT TO GRINDER PUMP AND CONTROL / ALARM

300 State Street, Suite 201 Rochester, NY 14614 585-454-6110


labellapc.com

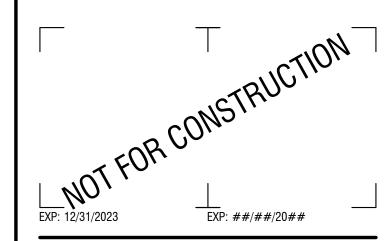

CERTIFICATE OF AUTHORIZATION NUMBER: PROFESSIONAL ENGINEERING: 095099 LAND SURVEYING: 017976 GEOLOGICAL: 018750

It is a violation of New York Education Law Art. 145 Sec. 7209 & Art. 147 Sec. 7307, for any person, unless acting under the direction of a licensed architect, professional engineer, or land surveyor, to alter an item in any way. If an item bearing the seal of an architect, engineer, or land surveyor is altered; the altering architect, engineer, or land surveyor shall affix to the item their seal and notation "altered by" followed by their signature and date of such alteration, and a specific description of the alteration.

© 2023 LaBella Associates

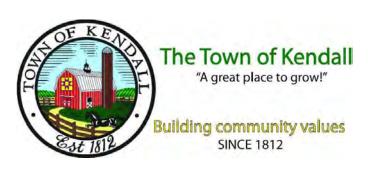


#### **REDI WASTEWATER** INFRASTRUCTURE (CONTRACT 1)


TOWN OF KENDALL & TOWN OF HAMLIN

NO:	DATE:	DESCRIPTION:
Revisions		
PROJECT	NUMBER:	2200455
DRAWN B	V.	
DRAWN B	Υ.	JCB
REVIEWED BY:		JRE
ISSUED FO	nr.	OTTE
IOOOLD I'		DESIGN SUBMISSION
DATE:		SEPTEMBER 2023
		OLI ILIVIDLII 2020

# **LOW PRESSURE SEWER PLAN** & PROFILES (BALD EAGLE MARINA)



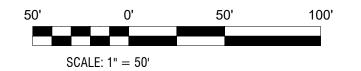

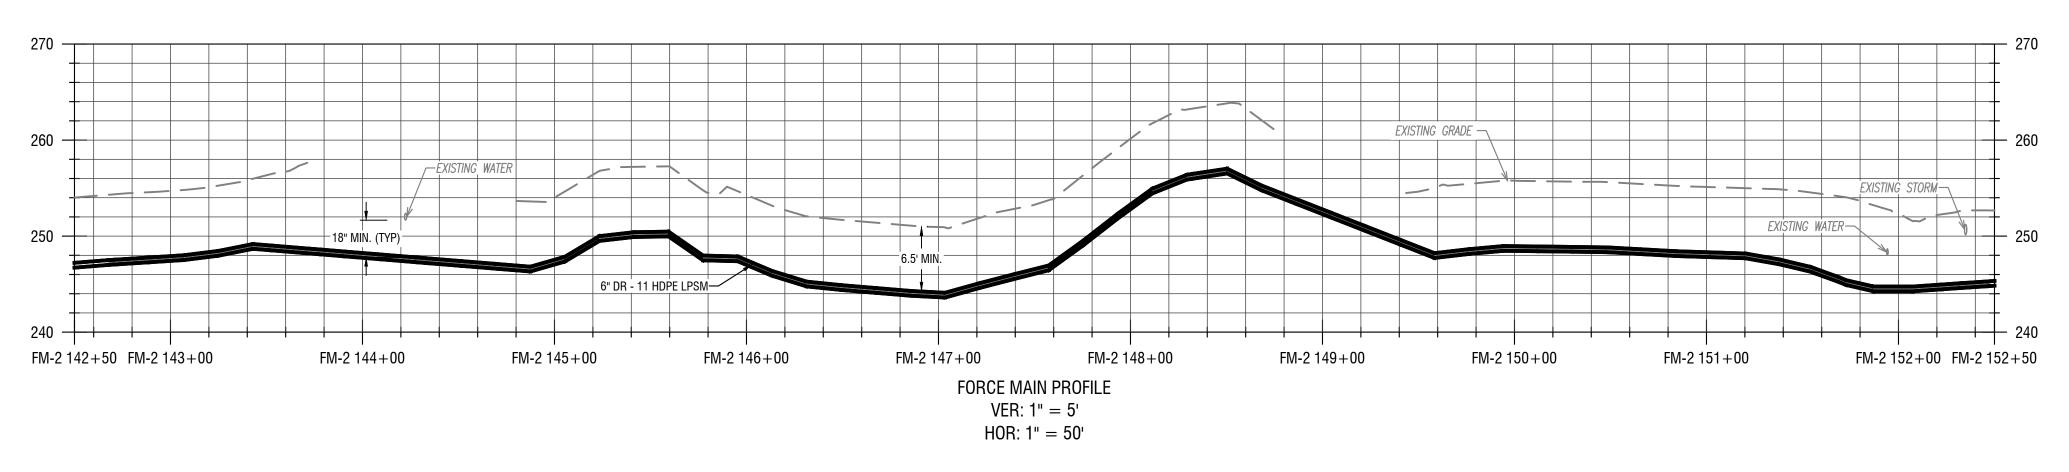

2 LOW PRESSURE SEWER PROFILE

C323 VERT: 1' = 5'
HORIZ: 1' = 50'


KEY NOTES

- 1 GRINDER PUMPS WITH REMOTE VENTING
- 2 INSTALL ALARM PANEL (FURNISHED BY OWNER), MOUNTED TO HOUSE
- INSTALL ALARM PANEL (FURNISHED BY OWNER),
  MOUNTED TO POST
- PROVIDE ONE 3/4", PVC CONDUIT BETWEEN THE PUMP CONTROL / ALARM PANEL & THE GRINDER PUMP. INSTALL ELECTRICAL SUPPLY CABLE (ESC) PROVIDED WITH PUMP CONNECT TO GRINDER PUMP AND CONTROL / ALARM PANEL.

LaBella
Powered by partnership.

300 State Street, Suite 201 Rochester, NY 14614 585-454-6110

labellapc.com

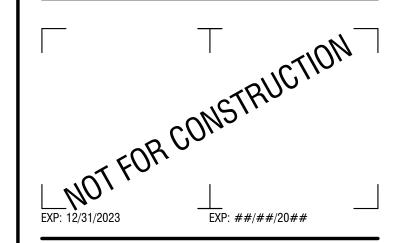

CERTIFICATE OF AUTHORIZATION NUMBER: PROFESSIONAL ENGINEERING: 095099 LAND SURVEYING: 017976 GEOLOGICAL: 018750

It is a violation of New York Education Law Art. 145 Sec. 7209 & Art. 147 Sec. 7307, for any person, unless acting under the direction of a licensed architect, professional engineer, or land surveyor, to alter an item in any way. If an item bearing the seal of an architect, engineer, or land surveyor is altered; the altering architect, engineer, or land surveyor shall affix to the item their seal and notation "altered by" followed by their signature and date of such alteration, and a specific description of the alteration.

© 2023 LaBella Associates




# REDI WASTEWATER INFRASTRUCTURE (CONTRACT 1)

TOWN OF KENDALL & TOWN OF HAMLIN

NO:	DATE:	DESCRIPTION:
Revisions		
PROJECT NU	MBER:	2200455
		2200400
DRAWN BY:		
REVIEWED B	٧.	JCB
VENIEMED D	Τ.	JRE
ISSUED FOR:		
	60% l	DESIGN SUBMISSION
DATE:	0	
	S	EPTEMBER 2023
DRAWING NA	AME:	

# LOW PRESSURE SEWER PLAN & PROFILES (BALD EAGLE MARINA)

DRAWING NUMBER:

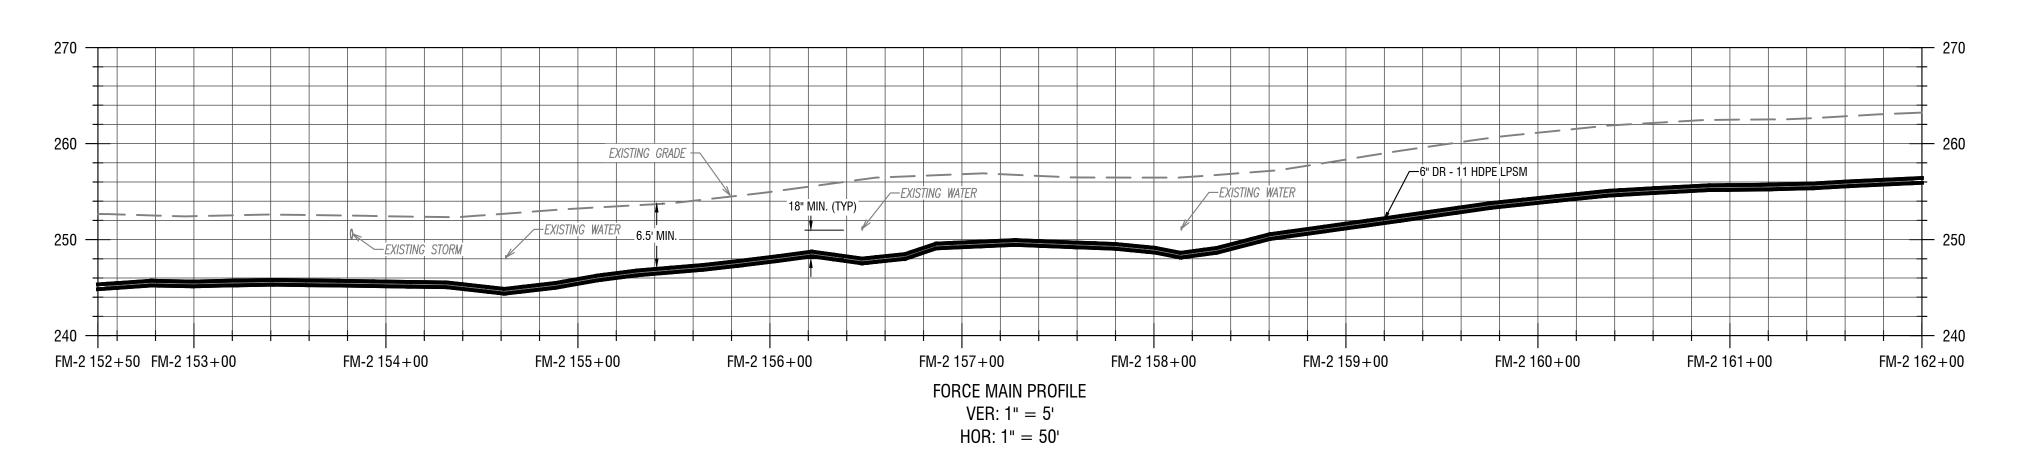

LOW PRESSURE SEWER PROFILE VERT: 1' = 5' HORIZ: 1' = 50'


KEY NOTES

- 1 GRINDER PUMPS WITH REMOTE VENTING
- 2 INSTALL ALARM PANEL (FURNISHED BY OWNER), MOUNTED TO HOUSE
- INSTALL ALARM PANEL (FURNISHED BY OWNER), MOUNTED TO POST
- PROVIDE ONE  $\frac{3}{4}$ , PVC CONDUIT BETWEEN THE PUMP CONTROL / ALARM PANEL & THE GRINDER PUMP. INSTALL ELECTRICAL SUPPLY CABLE (ESC) PROVIDED WITH PUMP - CONNECT TO GRINDER PUMP AND CONTROL / ALARM PANEL.

Powered by partnership.

300 State Street, Suite 201 Rochester, NY 14614 585-454-6110

labellapc.com

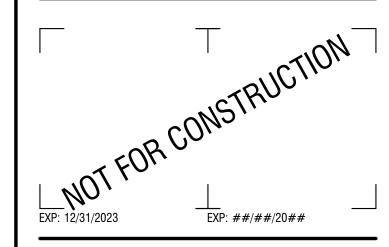

CERTIFICATE OF AUTHORIZATION NUMBER: PROFESSIONAL ENGINEERING: 095099 LAND SURVEYING: 017976 GEOLOGICAL: 018750

It is a violation of New York Education Law Art. 145 Sec. 7209 & Art. 147 Sec. 7307, for any person, unless acting under the direction of a licensed architect, professional engineer, or land surveyor, to alter an item in any way. If an item bearing the seal of an architect, engineer, or land surveyor is altered; the altering architect, engineer, or land surveyor shall affix to the item their seal and notation "altered by" followed by their signature and date of such alteration, and a specific description of the alteration.

© 2023 LaBella Associates




### **REDI WASTEWATER INFRASTRUCTURE** (CONTRACT 1)

TOWN OF KENDALL & TOWN OF HAMLIN

NO:	DATE:	DESCRIPTION:
Revisions		
PROJECT NU	JMBER:	2200455
		2200433
DRAWN BY:		
REVIEWED E	V·	JCB
TIEVIEWED E		JRE
ISSUED FOR		DEGLON OURNAGOLON
	6U% I	DESIGN SUBMISSION
DATE:	0	
	S	EPTEMBER 2023
DRAWING N	AME:	

# LOW PRESSURE SEWER PLAN & PROFILES (BALD EAGLE DR)

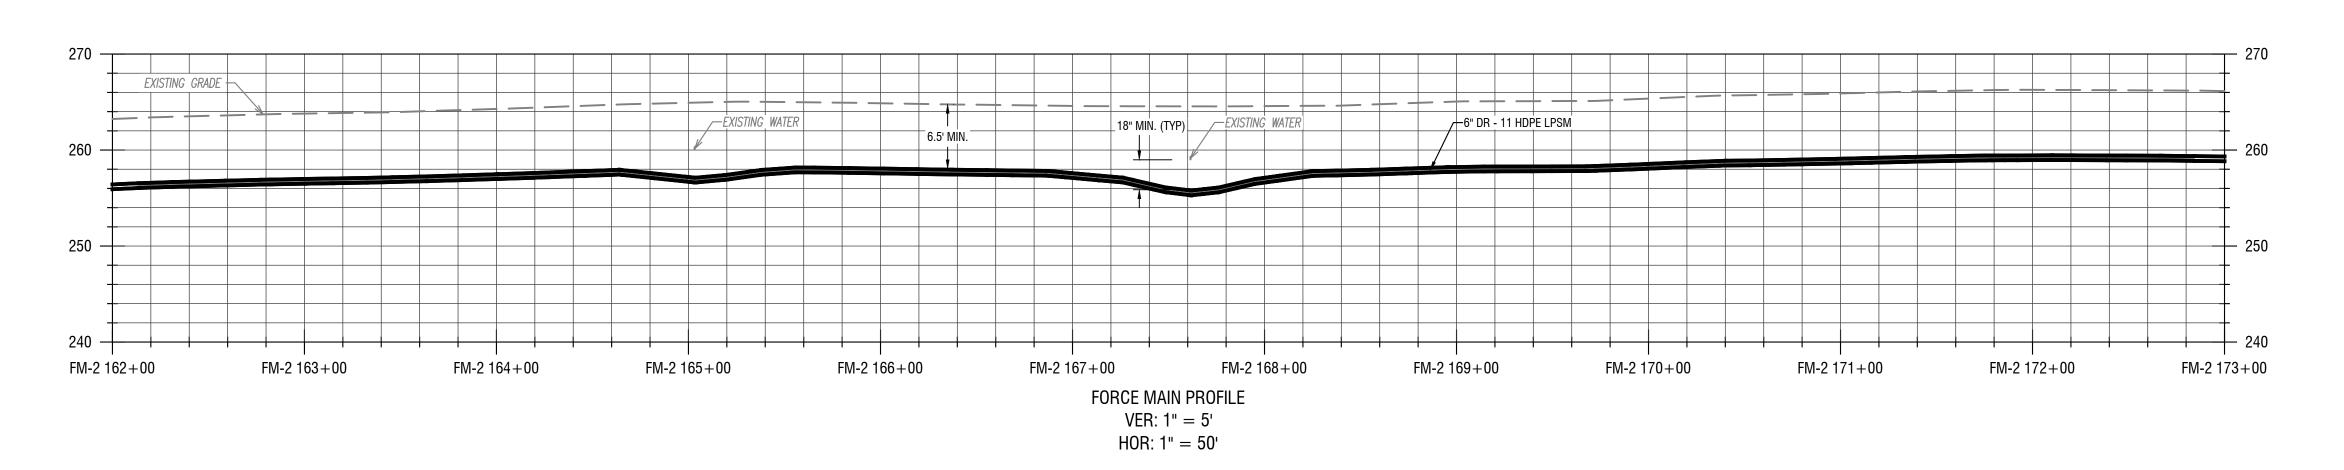

LOW PRESSURE SEWER PROFILE C325 VERT: 1' = 5' HORIZ: 1' = 50'

KEY NOTES

CH LINE (SEE SHEET C326)

SET NORTH EAST BONNET BOLT O

NOVAK ROGER


- 1 GRINDER PUMPS WITH REMOTE VENTING
- 2 INSTALL ALARM PANEL (FURNISHED BY OWNER), MOUNTED TO HOUSE
- 3 INSTALL ALARM PANEL (FURNISHED BY OWNER), MOUNTED TO POST
- PROVIDE ONE  $\frac{3}{4}$ , PVC CONDUIT BETWEEN THE PUMP CONTROL / ALARM PANEL & THE

GRINDER PUMP. INSTALL ELECTRICAL SUPPLY CABLE (ESC) PROVIDED WITH PUMP - CONNECT TO GRINDER PUMP AND CONTROL / ALARM PANEL.

Powered by partnership.

300 State Street, Suite 201 Rochester, NY 14614 585-454-6110


labellapc.com

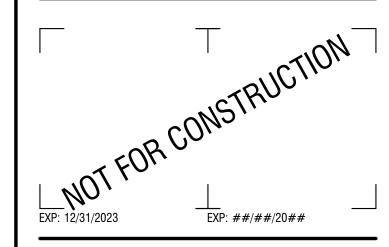

CERTIFICATE OF AUTHORIZATION NUMBER: PROFESSIONAL ENGINEERING: 095099 LAND SURVEYING: 017976 GEOLOGICAL: 018750

It is a violation of New York Education Law Art. 145 Sec. 7209 & Art. 147 Sec. 7307, for any person, unless acting under the direction of a licensed architect, professional engineer, or land surveyor, to alter an item in any way. If an item bearing the seal of an architect, engineer, or land surveyor is altered; the altering architect, engineer, or land surveyor shall affix to the item their seal and notation "altered by" followed by their signature and date of such alteration, and a specific description of the alteration.

© 2023 LaBella Associates

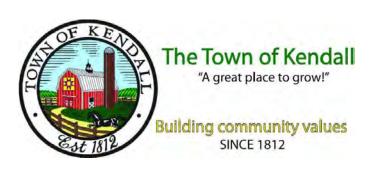

#### **REDI WASTEWATER INFRASTRUCTURE** (CONTRACT 1)


TOWN OF KENDALL & TOWN OF HAMLIN

NO.			
NO:	DATE:	DESCRIPTION:	
Revisions			
PROJECT NUM	BER:	2200455	
DRAWN BY:			
DEVIEWED DV		JCB	
REVIEWED BY:		JRE	
ISSUED FOR:	60% I	DESIGN SUBMISSION	
DATE:	S	EPTEMBER 2023	

# LOW PRESSURE SEWER PLAN & PROFILES (BALD EAGLE DR)

DRAWING NUMBER:

DRAWING NAME:

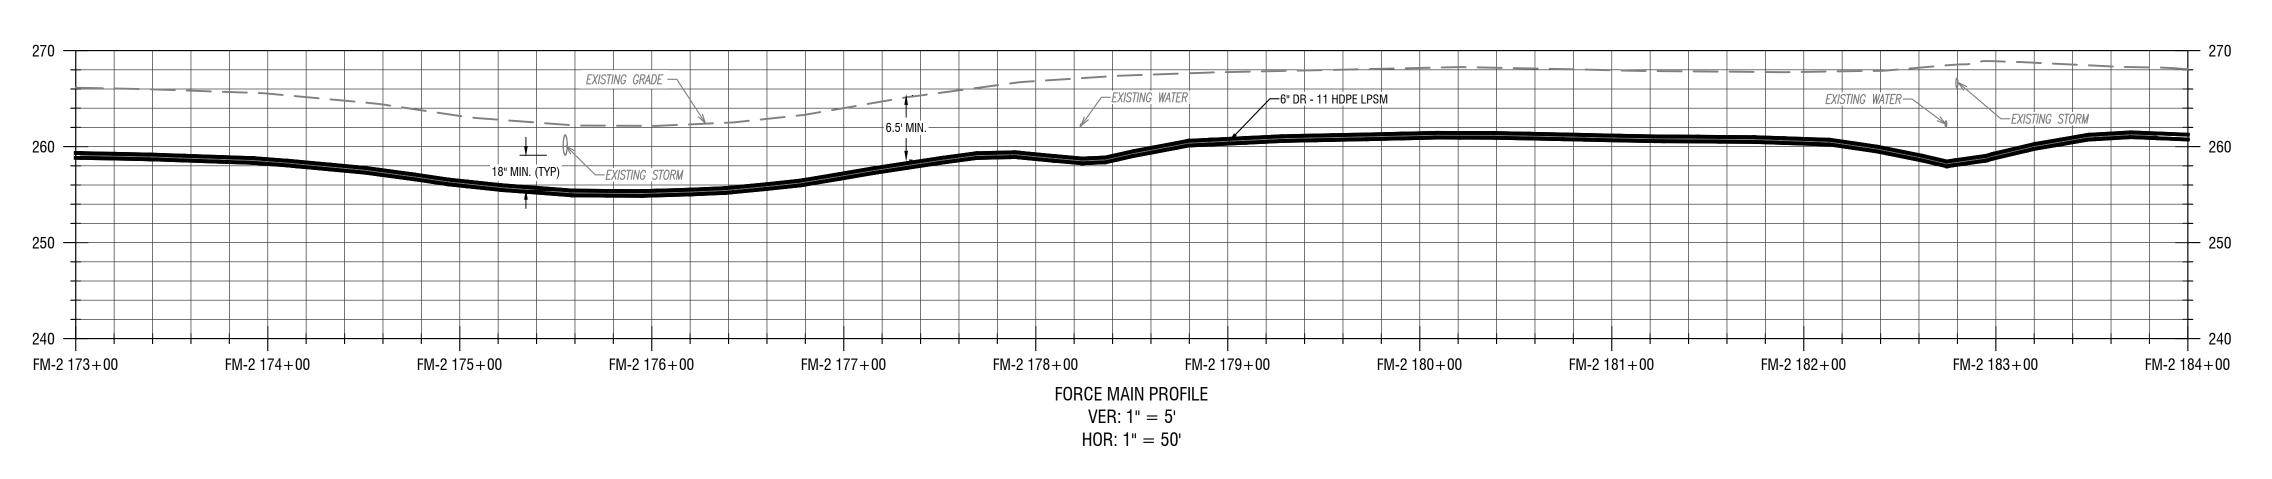


LOW PRESSURE SEWER PROFILE C326 VERT: 1' = 5' HORIZ: 1' = 50'

KEY NOTES

- 1 GRINDER PUMPS WITH REMOTE VENTING
- 2 INSTALL ALARM PANEL (FURNISHED BY OWNER), MOUNTED TO HOUSE
- 3 INSTALL ALARM PANEL (FURNISHED BY OWNER), MOUNTED TO POST
- PROVIDE ONE  $\frac{3}{4}$ ", PVC CONDUIT BETWEEN THE PUMP CONTROL / ALARM PANEL & THE GRINDER PUMP. INSTALL ELECTRICAL SUPPLY CABLE (ESC) PROVIDED WITH PUMP - CONNECT TO GRINDER PUMP AND CONTROL / ALARM PANEL.

300 State Street, Suite 201 Rochester, NY 14614 585-454-6110


labellapc.com

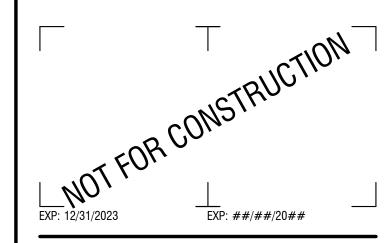

CERTIFICATE OF AUTHORIZATION NUMBER: PROFESSIONAL ENGINEERING: 095099 LAND SURVEYING: 017976 GEOLOGICAL: 018750

It is a violation of New York Education Law Art. 145 Sec. 7209 & Art. 147 Sec. 7307, for any person, unless acting under the direction of a licensed architect, professional engineer, or land surveyor, to alter an item in any way. If an item bearing the seal of an architect, engineer, or land surveyor is altered; the altering architect, engineer, or land surveyor shall affix to the item their seal and notation "altered by" followed by their signature and date of such alteration, and a specific description of the alteration.

© 2023 LaBella Associates

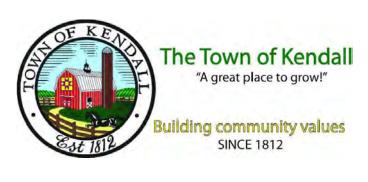


# **REDI WASTEWATER INFRASTRUCTURE** (CONTRACT 1)

TOWN OF KENDALL & TOWN OF HAMLIN

NO:	DATE:	DESCRIPTION:
Revisions		
PROJECT NUM	/IBER:	2200455
DRAWN BY:		
REVIEWED BY	·.	JCB
NEVIEWED DI	•	JRE
ISSUED FOR:	60% I	DESIGN SUBMISSION
DATE:	S	EPTEMBER 2023
DRAWING NAI	ME:	

# LOW PRESSURE SEWER PLAN & PROFILES (BALD EAGLE DR)

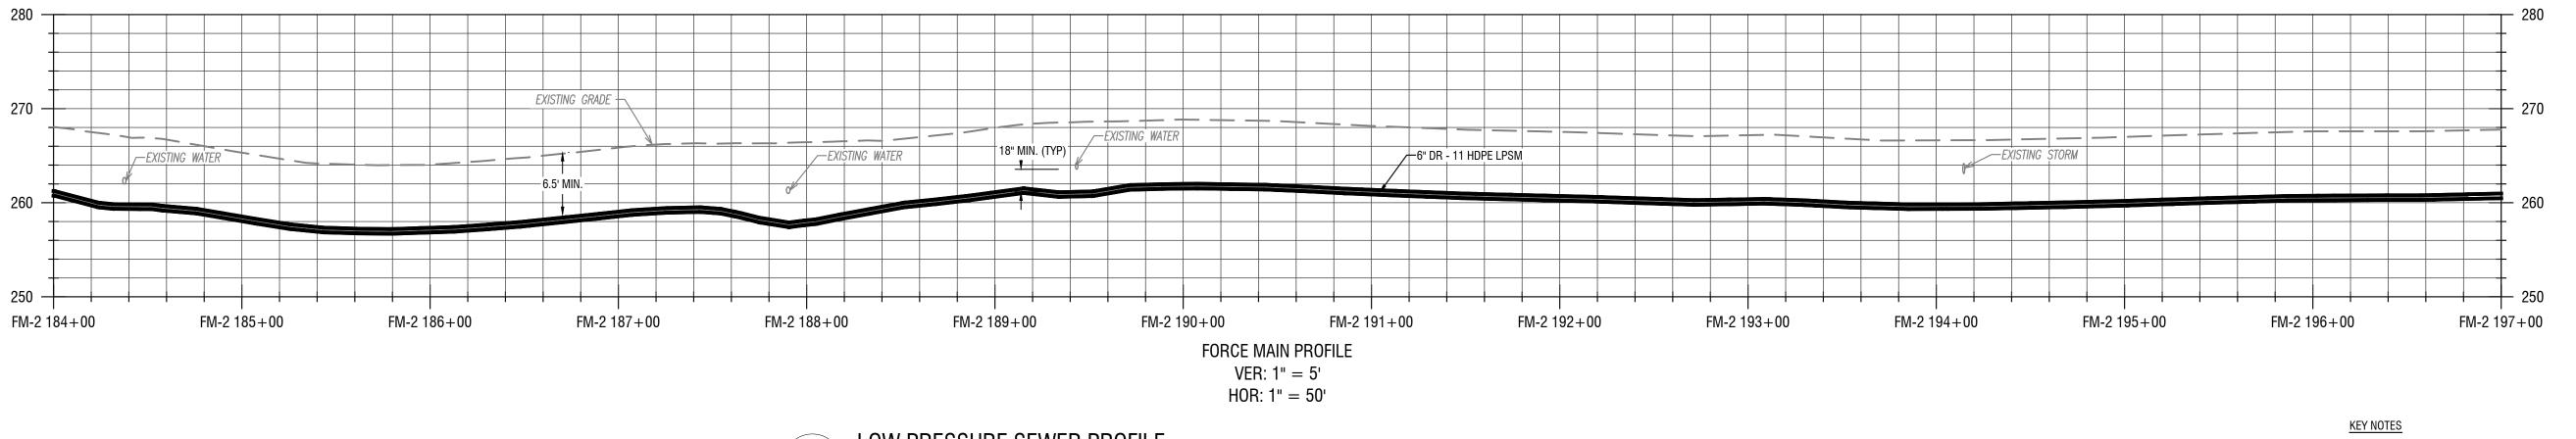


LOW PRESSURE SEWER PROFILE C327 VERT: 1' = 5' HORIZ: 1' = 50'

- 1 GRINDER PUMPS WITH REMOTE VENTING
- 2 INSTALL ALARM PANEL (FURNISHED BY OWNER), MOUNTED TO HOUSE
- INSTALL ALARM PANEL (FURNISHED BY OWNER), MOUNTED TO POST
- PROVIDE ONE  $\frac{3}{4}$ ", PVC CONDUIT BETWEEN THE PUMP CONTROL / ALARM PANEL & THE GRINDER PUMP. INSTALL ELECTRICAL SUPPLY CABLE (ESC) PROVIDED WITH PUMP - CONNECT TO GRINDER PUMP AND CONTROL / ALARM PANEL.

300 State Street, Suite 201 Rochester, NY 14614 585-454-6110


labellapc.com

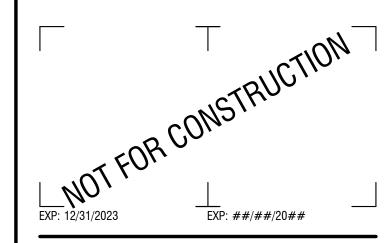

CERTIFICATE OF AUTHORIZATION NUMBER: PROFESSIONAL ENGINEERING: 095099 LAND SURVEYING: 017976 GEOLOGICAL: 018750

It is a violation of New York Education Law Art. 145 Sec. 7209 & Art. 147 Sec. 7307, for any person, unless acting under the direction of a licensed architect, professional engineer, or land surveyor, to alter an item in any way. If an item bearing the seal of an architect, engineer, or land surveyor is altered; the altering architect, engineer, or land surveyor shall affix to the item their seal and notation "altered by" followed by their signature and date of such alteration, and a specific description of the alteration.

© 2023 LaBella Associates

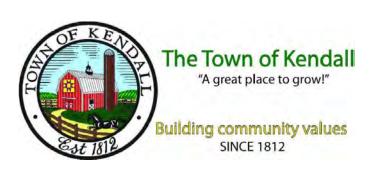

### **REDI WASTEWATER INFRASTRUCTURE** (CONTRACT 1)


TOWN OF KENDALL & TOWN OF HAMLIN

NO:	DATE:	DESCRIPTION:
Revisions		
PROJECT NI	JMBER:	2200455
DRAWN BY:		IOD
REVIEWED E	RY∙	JCB
TIEVIEWED I		JRE
ISSUED FOR		DECION CHDMICCION
	0U% I	DESIGN SUBMISSION
DATE:	C	EDTEMPED 2022
	5	EPTEMBER 2023
DRAWING N	AME:	

# LOW PRESSURE SEWER PLAN & PROFILES (NORWAY HEIGHTS)

LOW PRESSURE SEWER PLAN C328 HORIZ: 1' = 50'



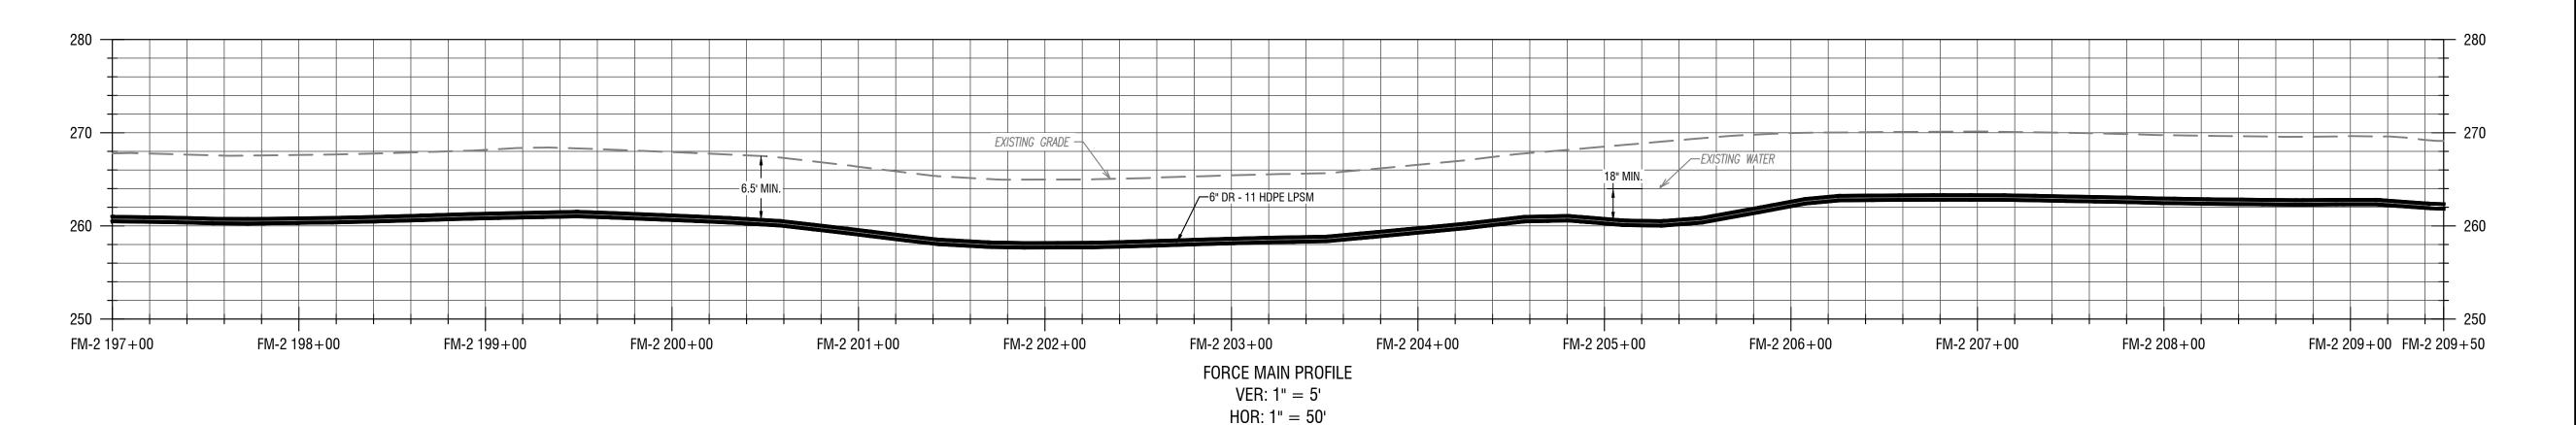

C328 VERT: 1' = 5' HORIZ: 1' = 50'


LOW PRESSURE SEWER PROFILE

KEY NOTES

- 1 GRINDER PUMPS WITH REMOTE VENTING
- 2 INSTALL ALARM PANEL (FURNISHED BY OWNER), MOUNTED TO HOUSE
- (3) INSTALL ALARM PANEL (FURNISHED BY OWNER), MOUNTED TO POST
- PROVIDE ONE  $\frac{3}{4}$ , PVC CONDUIT BETWEEN THE PUMP CONTROL / ALARM PANEL & THE GRINDER PUMP. INSTALL ELECTRICAL SUPPLY CABLE (ESC) PROVIDED WITH PUMP - CONNECT TO GRINDER PUMP AND CONTROL / ALARM PANEL.

300 State Street, Suite 201 Rochester, NY 14614 585-454-6110

labellapc.com

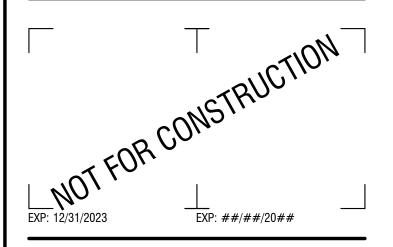

CERTIFICATE OF AUTHORIZATION NUMBER: PROFESSIONAL ENGINEERING: 095099 LAND SURVEYING: 017976 GEOLOGICAL: 018750

It is a violation of New York Education Law Art. 145 Sec. 7209 & Art. 147 Sec. 7307, for any person, unless acting under the direction of a licensed architect, professional engineer, or land surveyor, to alter an item in any way. If an item bearing the seal of an architect, engineer, or land surveyor is altered; the altering architect, engineer, or land surveyor shall affix to the item their seal and notation "altered by" followed by their signature and date of such alteration, and a specific description of the alteration.

© 2023 LaBella Associates



# **REDI WASTEWATER INFRASTRUCTURE** (CONTRACT 1)


TOWN OF KENDALL & TOWN OF HAMLIN


ΓΕ:	DESCRIPTION:
₹:	2200455
	JCB
	JRE
60% I	DESIGN SUBMISSION
	EPTEMBER 2023

DRAWING NAME:

# LOW PRESSURE SEWER PLAN & PROFILES (NORWAY HEIGHTS)



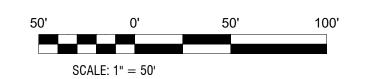

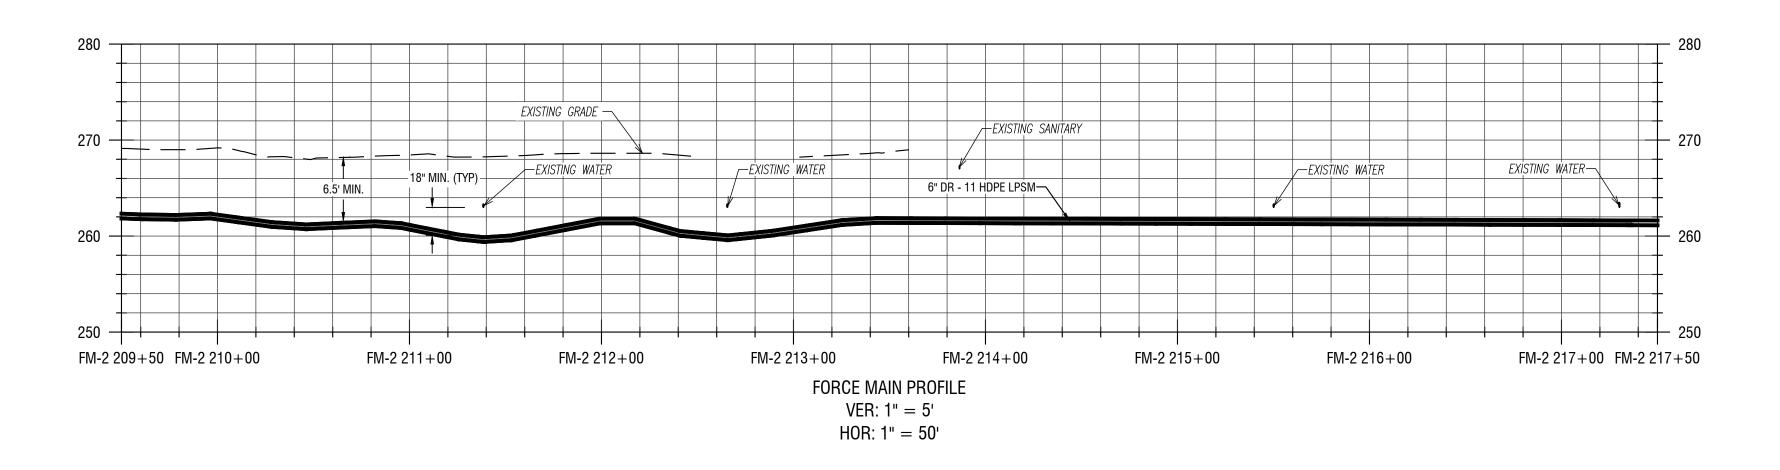


2 LOW PRESSURE SEWER PROFILE

C329 VERT: 1' = 5'
HORIZ: 1' = 50'



300 State Street, Suite 201 Rochester, NY 14614 585-454-6110

labellapc.com

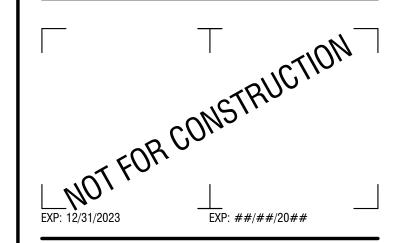

CERTIFICATE OF AUTHORIZATION NUMBER: PROFESSIONAL ENGINEERING: 095099 LAND SURVEYING: 017976 GEOLOGICAL: 018750

It is a violation of New York Education Law Art. 145 Sec. 7209 & Art. 147 Sec. 7307, for any person, unless acting under the direction of a licensed architect, professional engineer, or land surveyor, to alter an item in any way. If an item bearing the seal of an architect, engineer, or land surveyor is altered; the altering architect, engineer, or land surveyor shall affix to the item their seal and notation "altered by" followed by their signature and date of such alteration, and a specific description of the alteration.

© 2023 LaBella Associates



# REDI WASTEWATER INFRASTRUCTURE (CONTRACT 1)

TOWN OF KENDALL & TOWN OF HAMLIN

NO:	DATE:	DESCRIPTION:
Revisions		
PROJECT N	IUMBER:	2200455
		2200455
DRAWN BY	<b>'</b> :	
DRAWN BY		JCB

60% DESIGN SUBMISSION

DATE: SEPTEMBER 2023

DRAWING NAME:

# LOW PRESSURE SEWER PLAN & PROFILES (COTTAGES AT TROUTBURG)

DRAWING NUMBER:


EXISTING STORM— −6" DR - 11 HDPE LPSM -EXISTING WATER \_\_EXISTING WATER EXISTING WATER \_EXISTING WATER FM-2 217+50 FM-2 218+00 FM-2 220+00 FM-2 219+00 FM-2 221+00 FM-2 222+00 FM-2 223+00 FM-2 224+00 FM-2 225+00 FM-2 226+00 FM-2 227+00 FM-2 228+00 FM-2 229+00 FM-2 229+50 FORCE MAIN PROFILE VER: 1" = 5' HOR: 1" = 50'



LaBella
Powered by partnership

300 State Street, Suite 201 Rochester, NY 14614 585-454-6110

labellapc.com

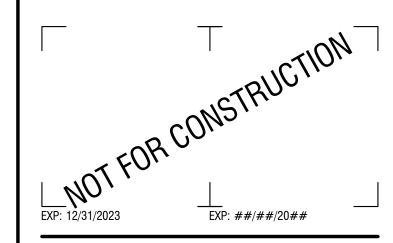

CERTIFICATE OF AUTHORIZATION NUMBER: PROFESSIONAL ENGINEERING: 095099 LAND SURVEYING: 017976 GEOLOGICAL: 018750

It is a violation of New York Education Law Art. 145 Sec. 7209 & Art. 147 Sec. 7307, for any person, unless acting under the direction of a licensed architect, professional engineer, or land surveyor, to alter an item in any way. If an item bearing the seal of an architect, engineer, or land surveyor is altered; the altering architect, engineer, or land surveyor shall affix to the item their seal and notation "altered by" followed by their signature and date of such alteration, and a specific description of the alteration.

© 2023 LaBella Associates



# REDI WASTEWATER INFRASTRUCTURE (CONTRACT 1)

TOWN OF KENDALL & TOWN OF HAMLIN


NO:	DATE:	DESCRIPTION:
Revisions		
PROJECT N	NUMBER:	2200455
DRAWN BY	<b>/:</b>	100
REVIEWED	BY:	JCB
		JRE
ISSUED FO		DESIGN SUBMISSION
DATE:	Ç	SEPTEMBER 2023

# LOW PRESSURE SEWER PLAN & PROFILES (COTTAGES AT TROUTBURG)

DRAWING NUMBER:



50' 0' 50' 100' SCALE: 1" = 50'

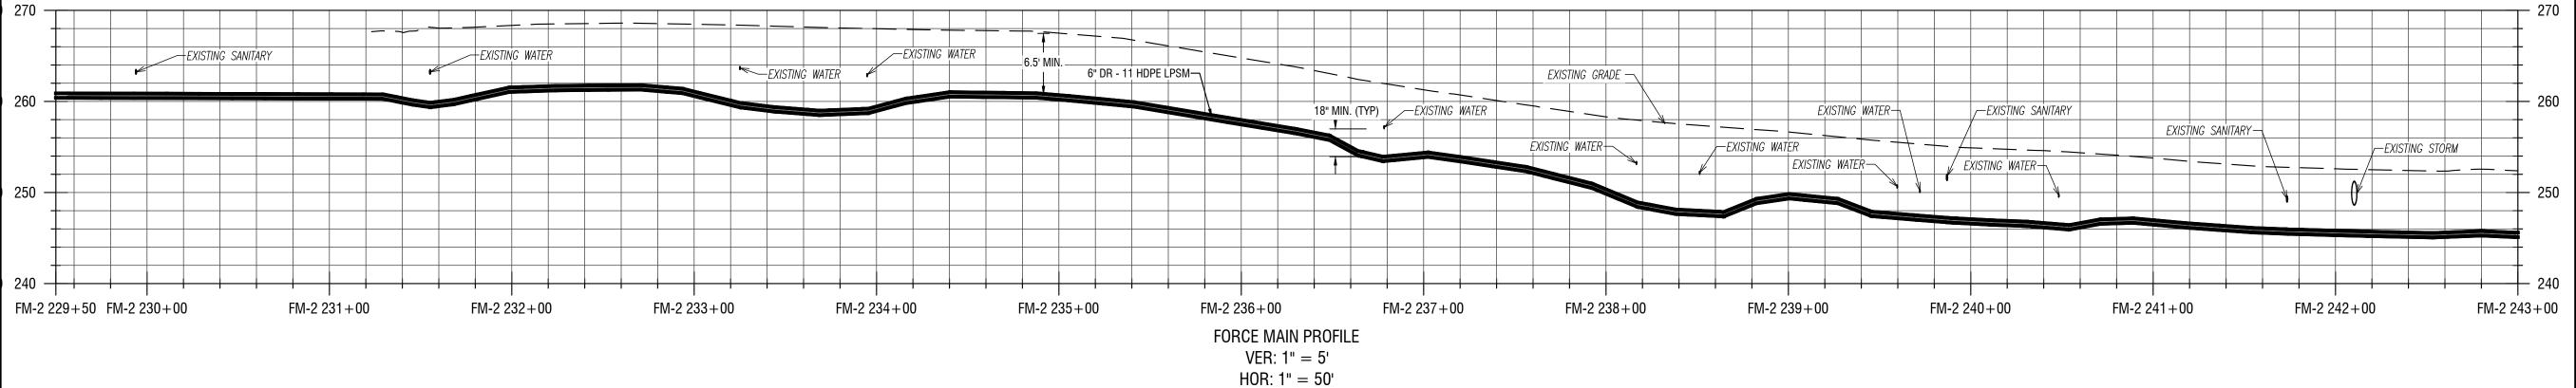

2 LOW PRESSURE SEWER PROFILE

C331 VERT: 1' = 5'
HORIZ: 1' = 50'


LOW PRESSURE SEWER PLAN

C331 HORIZ: 1' = 50'

LaBella
Powered by partnership.

300 State Street, Suite 201 Rochester, NY 14614 585-454-6110

labellapc.com

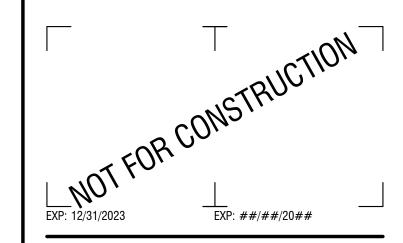

CERTIFICATE OF AUTHORIZATION NUMBER: PROFESSIONAL ENGINEERING: 095099 LAND SURVEYING: 017976 GEOLOGICAL: 018750

It is a violation of New York Education Law Art. 145 Sec. 7209 & Art. 147 Sec. 7307, for any person, unless acting under the direction of a licensed architect, professional engineer, or land surveyor, to alter an item in any way. If an item bearing the seal of an architect, engineer, or land surveyor is altered; the altering architect, engineer, or land surveyor shall affix to the item their seal and notation "altered by" followed by their signature and date of such alteration, and a specific description of the alteration.

© 2023 LaBella Associates




# REDI WASTEWATER INFRASTRUCTURE (CONTRACT 1)

TOWN OF KENDALL & TOWN OF HAMLIN

DATE:	DESCRIPTION:
LIMBED	
UMBEK:	2200455
RV·	JCB
ы.	JRE
R: 60%	DESIGN SUBMISSION
S	SEPTEMBER 2023
	UMBER: BY: R: 60%


# LOW PRESSURE SEWER PLAN & PROFILES (MAIN STREET)

DRAWING NUMBER:

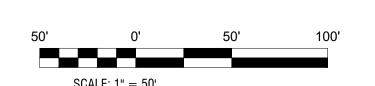

LOW PRESSURE SEWER PLAN

C332 HORIZ: 1' = 50'

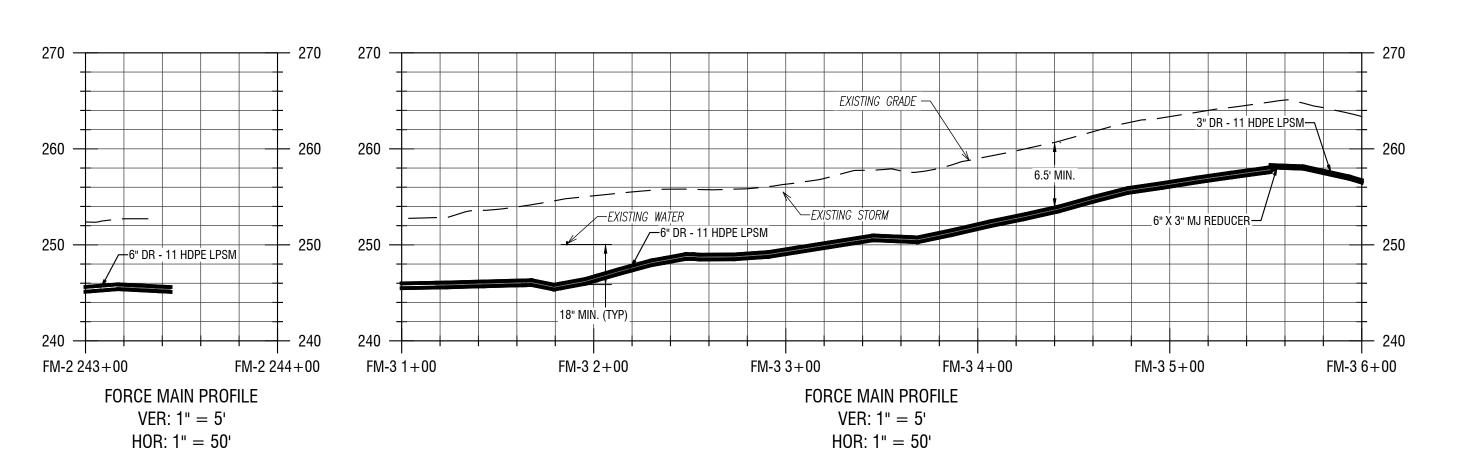


2 LOW PRESSURE SEWER PROFILE

C332 VERT: 1' = 5' HORIZ: 1' = 50' LaBella
Powered by partnership.

300 State Street, Suite 201 Rochester, NY 14614 585-454-6110

labellapc.com

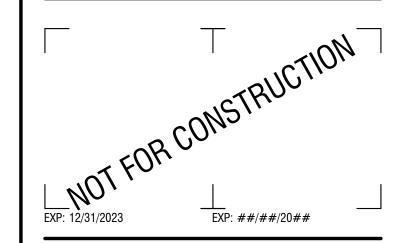

CERTIFICATE OF AUTHORIZATION NUMBER: PROFESSIONAL ENGINEERING: 095099 LAND SURVEYING: 017976 GEOLOGICAL: 018750

It is a violation of New York Education Law Art. 145 Sec. 7209 & Art. 147 Sec. 7307, for any person, unless acting under the direction of a licensed architect, professional engineer, or land surveyor, to alter an item in any way. If an item bearing the seal of an architect, engineer, or land surveyor is altered; the altering architect, engineer, or land surveyor shall affix to the item their seal and notation "altered by" followed by their signature and date of such alteration, and a specific description of the alteration.

© 2023 LaBella Associates



# REDI WASTEWATER INFRASTRUCTURE (CONTRACT 1)

TOWN OF KENDALL & TOWN OF HAMLIN

NO:	DATE:	DESCRIPTION:
Revisions		
PROJECT NUI	MBER:	2200455
		2200400
DRAWN BY:		JCB
REVIEWED BY	<b>′</b> :	

JRE

ISSUED FOR:


60% DESIGN SUBMISSION

DATE: SEPTEMBER 2023

DRAWING NAME:

LOW PRESSURE SEWER PLAN
& PROFILES
(MAIN STREET &
COUNTY LINE ROAD)

DRAWING NUMBER:

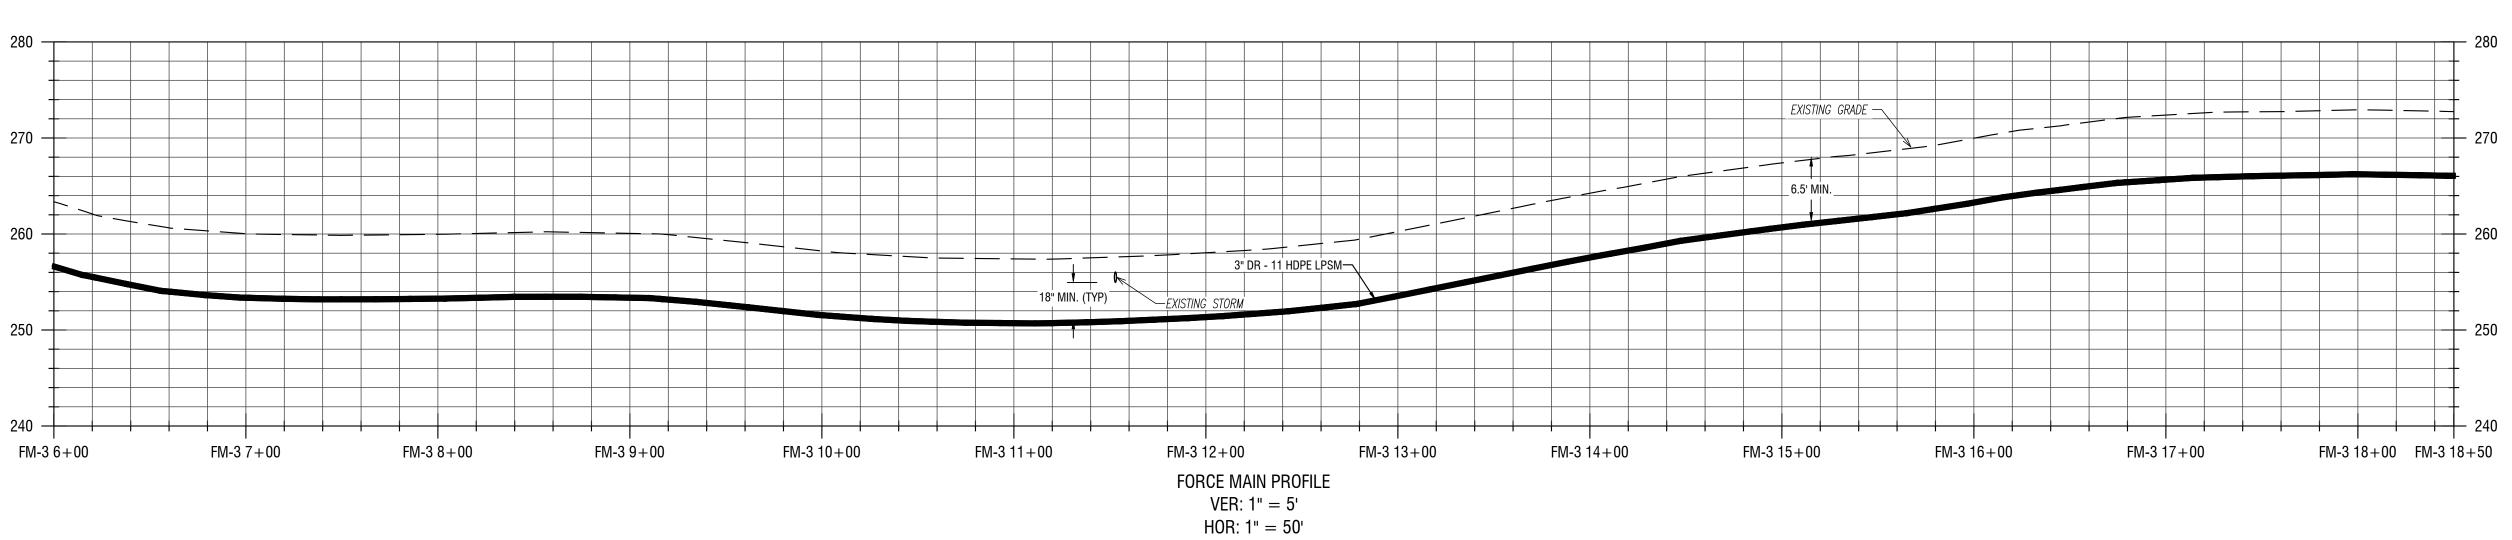


2 LOW PRESSURE SEWER PROFILE

C333 VERT: 1' = 5'
HORIZ: 1' = 50'

LaBella
Powered by partnership.

300 State Street, Suite 201 Rochester, NY 14614 585-454-6110

labellapc.com

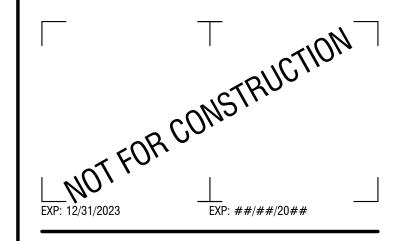

CERTIFICATE OF AUTHORIZATION NUMBER: PROFESSIONAL ENGINEERING: 095099 LAND SURVEYING: 017976 GEOLOGICAL: 018750

It is a violation of New York Education Law Art. 145 Sec. 7209 & Art. 147 Sec. 7307, for any person, unless acting under the direction of a licensed architect, professional engineer, or land surveyor, to alter an item in any way. If an item bearing the seal of an architect, engineer, or land surveyor is altered; the altering architect, engineer, or land surveyor shall affix to the item their seal and notation "altered by" followed by their signature and date of such alteration, and a specific description of the alteration.

© 2023 LaBella Associates



# REDI WASTEWATER INFRASTRUCTURE (CONTRACT 1)

TOWN OF KENDALL & TOWN OF HAMLIN

NO:	DATE:	DESCRIPTION:
Revisions		
PROJECT N	IUMBER:	2200455
DRAWN BY	<b>'</b> :	
REVIEWED	RV·	JCB
TILVILVVLD	DI.	JRE
ISSUED FO		DESIGN SUBMISSION
DATE:	5	SEPTEMBER 2023


# LOW PRESSURE SEWER PLAN & PROFILES (BEACHWOOD PARK RD)

DRAWING NUMBER:



300 State Street, Suite 201 Rochester, NY 14614 585-454-6110

labellapc.com

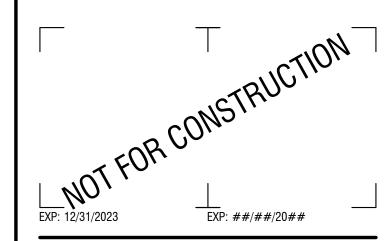

CERTIFICATE OF AUTHORIZATION NUMBER: PROFESSIONAL ENGINEERING: 095099 LAND SURVEYING: 017976 GEOLOGICAL: 018750

It is a violation of New York Education Law Art. 145 Sec. 7209 & Art. 147 Sec. 7307, for any person, unless acting under the direction of a licensed architect, professional engineer, or land surveyor, to alter an item in any way. If an item bearing the seal of an architect, engineer, or land surveyor is altered; the altering architect, engineer, or land surveyor shall affix to the item their seal and notation "altered by" followed by their signature and date of such alteration, and a specific description of the alteration.

© 2023 LaBella Associates




## REDI WASTEWATER INFRASTRUCTURE (CONTRACT 1)

TOWN OF KENDALL & TOWN OF HAMLIN

NO:	DATE:	DESCRIPTION:
Revisions		
PROJECT N	UMBER:	2200455
DRAWN BY	:	100
REVIEWED	RY·	JCB
TIEVIEWED	<b>5</b> 1.	JRE
ISSUED FOR		DESIGN SUBMISSION
DATE:	S	EPTEMBER 2023
DRAWING N	NAME:	

# LOW PRESSURE SEWER PLAN & PROFILES (BEACHWOOD PARK RD)

DRAWING NUMBER:

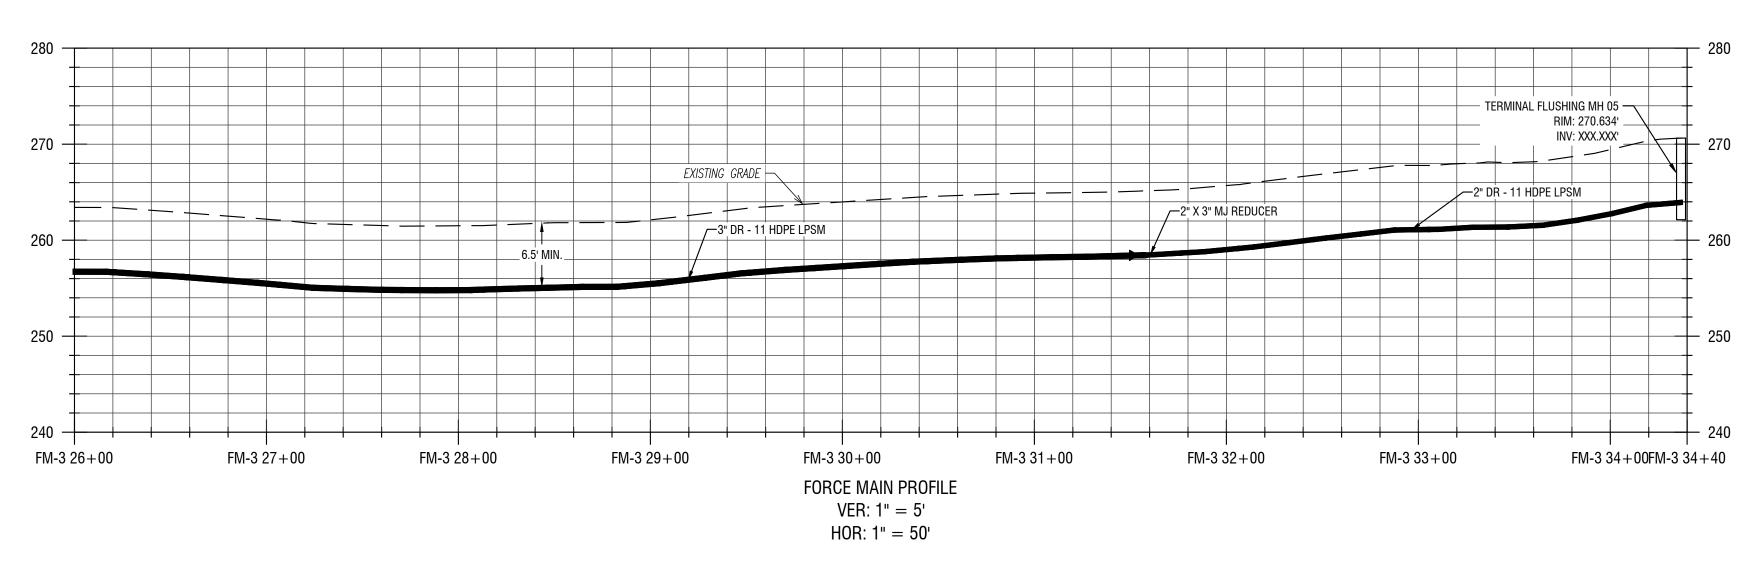


2 LOW PRESSURE SEWER PROFILE

C335 VERT: 1' = 5'
HORIZ: 1' = 50'

LaBella
Powered by partnership

300 State Street, Suite 201 Rochester, NY 14614 585-454-6110

labellapc.com

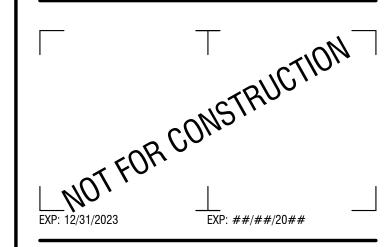

CERTIFICATE OF AUTHORIZATION NUMBER: PROFESSIONAL ENGINEERING: 095099 LAND SURVEYING: 017976 GEOLOGICAL: 018750

It is a violation of New York Education Law Art. 145 Sec. 7209 & Art. 147 Sec. 7307, for any person, unless acting under the direction of a licensed architect, professional engineer, or land surveyor, to alter an item in any way. If an item bearing the seal of an architect, engineer, or land surveyor is altered; the altering architect, engineer, or land surveyor shall affix to the item their seal and notation "altered by" followed by their signature and date of such alteration, and a specific description of the alteration.

© 2023 LaBella Associates



# REDI WASTEWATER INFRASTRUCTURE (CONTRACT 1)


TOWN OF KENDALL & TOWN OF HAMLIN

NO: [	DATE:	DESCRIPTION:
Revisions		
PROJECT NUME	SER:	2200455
DRAWN BY:		
DEVIEWED DV		JCB
REVIEWED BY:		JRE
ISSUED FOR:	60% I	DESIGN SUBMISSION
	UU /0 L	JESIGIV SUDIVIISSIUIV
DATE:	S	EPTEMBER 2023

DRAWING NAME:

# LOW PRESSURE SEWER PLAN & PROFILES (BEACHWOOD PARK RD)

DRAWING NUMBER:

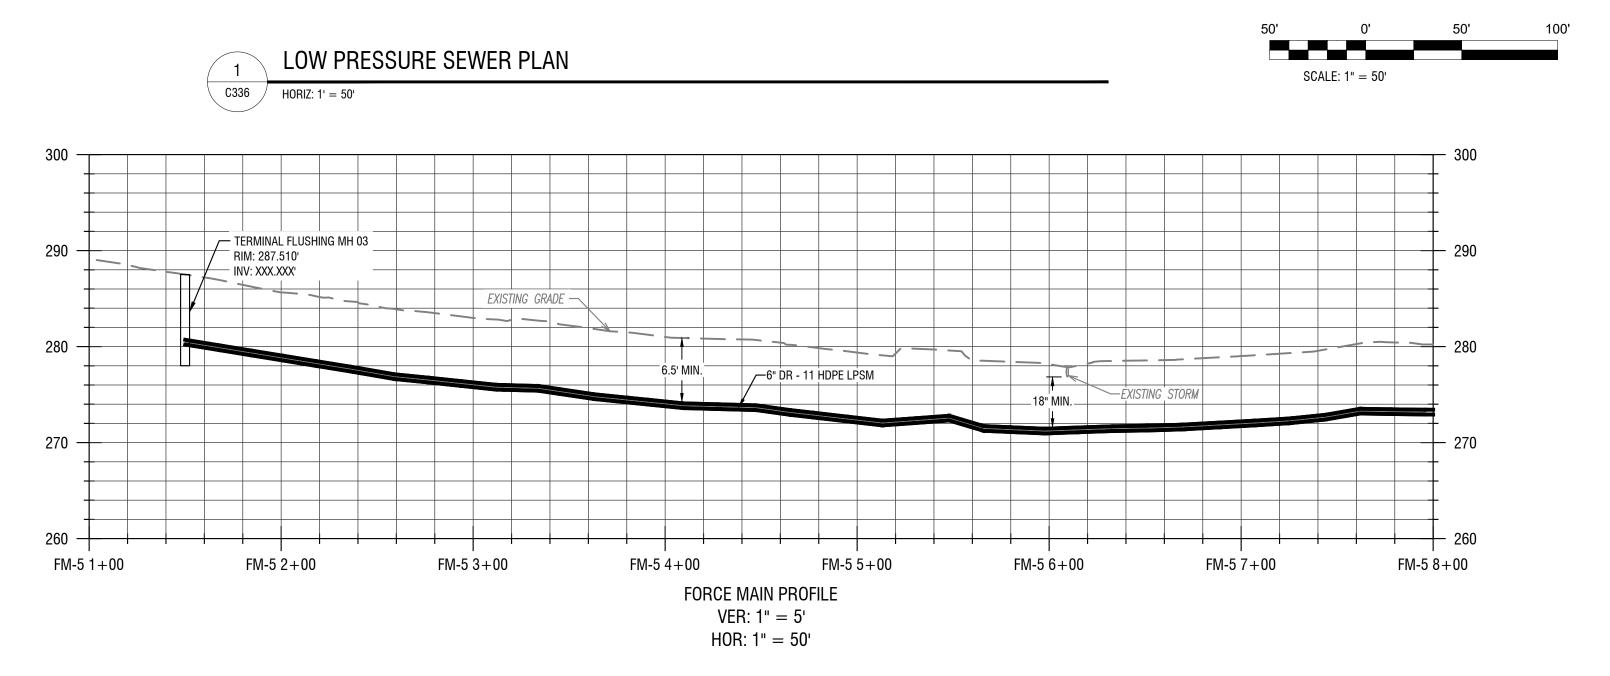


LOW PRESSURE SEWER PROFILE C336 VERT: 1' = 5' HORIZ: 1' = 50'

300 State Street, Suite 201

Rochester, NY 14614 585-454-6110

labellapc.com

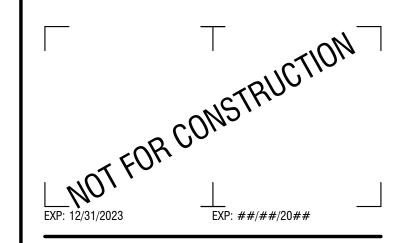

CERTIFICATE OF AUTHORIZATION NUMBER: PROFESSIONAL ENGINEERING: 095099 LAND SURVEYING: 017976 GEOLOGICAL: 018750

It is a violation of New York Education Law Art. 145 Sec. 7209 & Art. 147 Sec. 7307, for any person, unless acting under the direction of a licensed architect, professional engineer, or land surveyor, to alter an item in any way. If an item bearing the seal of an architect, engineer, or land surveyor is altered; the altering architect, engineer, or land surveyor shall affix to the item their seal and notation "altered by" followed by their signature and date of such alteration, and a specific description of the alteration.

© 2023 LaBella Associates



# **REDI WASTEWATER** INFRASTRUCTURE (CONTRACT 1)

TOWN OF KENDALL & TOWN OF HAMLIN

NO:	DATE:	DESCRIPTION:
Revisions		
PROJECT N	UMBER:	2200455
DRAWN BY:		
DEVIEWED I	<b>3</b> V.	JCB
REVIEWED I	5Y.	JRE
ISSUED FOF		DESIGN SUBMISSION
	00% [	วะอเน่ท อบอเพเออเบท
DATE:	S	EPTEMBER 2023
	J	LI ILIVIDLIT ZUZU

# LOW PRESSURE SEWER PLAN & PROFILES (NORWAY RD)

DRAWING NUMBER:

KEY NOTES


1 GRINDER PUMPS WITH REMOTE VENTING

2 INSTALL ALARM PANEL (FURNISHED BY OWNER), MOUNTED TO HOUSE

(3) INSTALL ALARM PANEL (FURNISHED BY OWNER), MOUNTED TO POST

GRINDER PUMP. INSTALL ELECTRICAL SUPPLY CABLE (ESC) PROVIDED WITH PUMP - CONNECT TO GRINDER PUMP AND CONTROL / ALARM

PROVIDE ONE  $\frac{3}{4}$ , PVC CONDUIT BETWEEN THE PUMP CONTROL / ALARM PANEL & THE

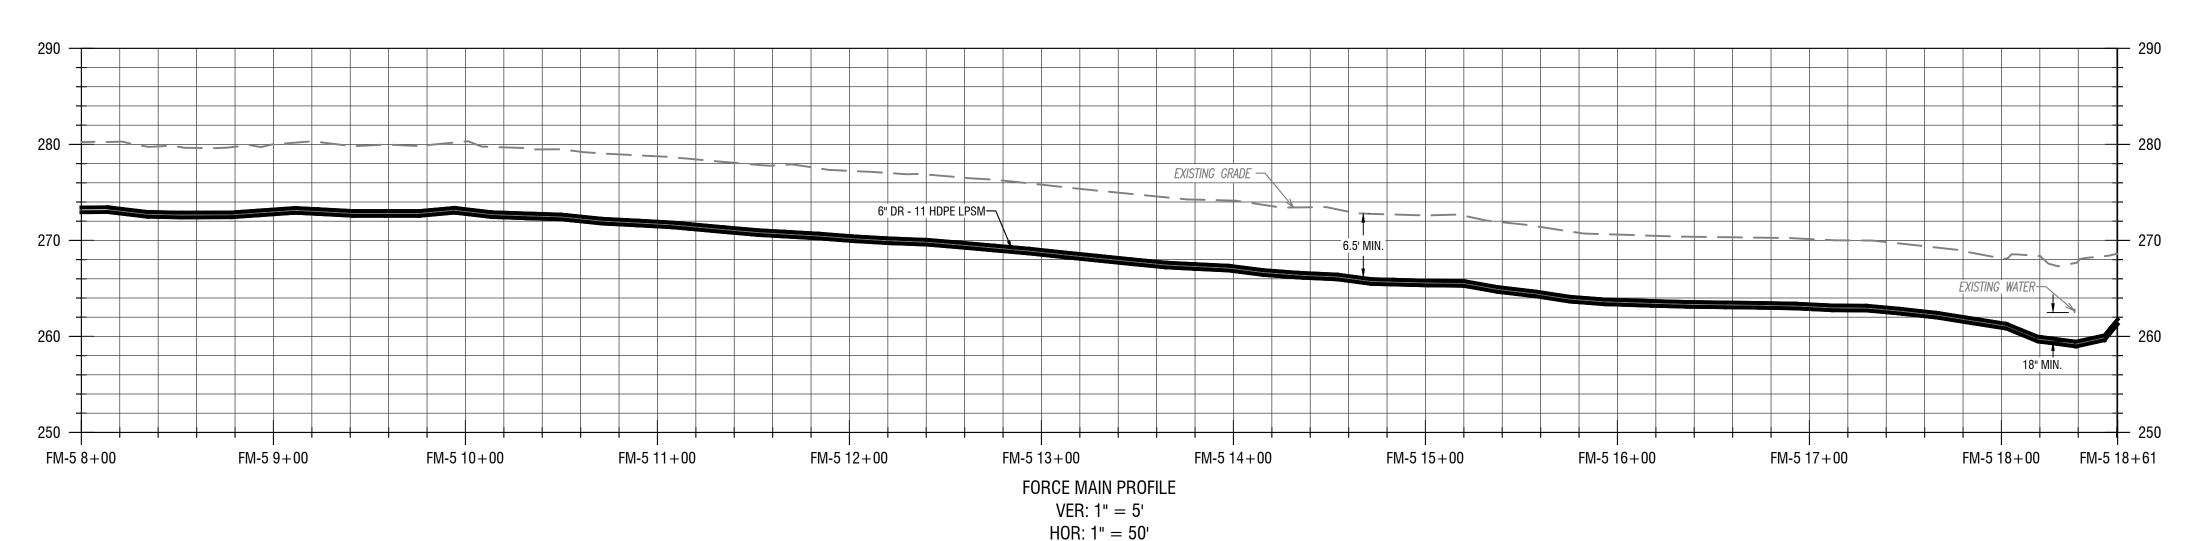

LOW PRESSURE SEWER PROFILE C337 VERT: 1' = 5' HORIZ: 1' = 50'


KEY NOTES

- 1 GRINDER PUMPS WITH REMOTE VENTING
- 2 INSTALL ALARM PANEL (FURNISHED BY OWNER), MOUNTED TO HOUSE
- (3) INSTALL ALARM PANEL (FURNISHED BY OWNER), MOUNTED TO POST
- PROVIDE ONE  $\frac{3}{4}$ , PVC CONDUIT BETWEEN THE PUMP CONTROL / ALARM PANEL & THE

GRINDER PUMP. INSTALL ELECTRICAL SUPPLY CABLE (ESC) PROVIDED WITH PUMP - CONNECT TO GRINDER PUMP AND CONTROL / ALARM PANEL.

300 State Street, Suite 201 Rochester, NY 14614 585-454-6110


labellapc.com

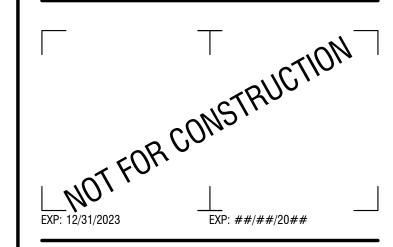

CERTIFICATE OF AUTHORIZATION NUMBER: PROFESSIONAL ENGINEERING: 095099 LAND SURVEYING: 017976 GEOLOGICAL: 018750

It is a violation of New York Education Law Art. 145 Sec. 7209 & Art. 147 Sec. 7307, for any person, unless acting under the direction of a licensed architect, professional engineer, or land surveyor, to alter an item in any way. If an item bearing the seal of an architect, engineer, or land surveyor is altered; the altering architect, engineer, or land surveyor shall affix to the item their seal and notation "altered by" followed by their signature and date of such alteration, and a specific description of the alteration.

© 2023 LaBella Associates

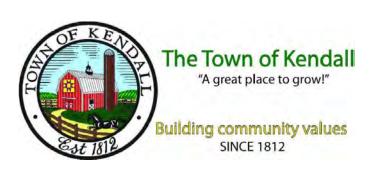


# **REDI WASTEWATER** INFRASTRUCTURE (CONTRACT 1)

TOWN OF KENDALL & TOWN OF HAMLIN

NO:	DATE:	DESCRIPTION:
Revisions		
PROJECT NUN	/IBER:	2200455
DRAWN BY:		IOD
REVIEWED BY	<i>.</i> .	JCB
TILVILVVLD DI	•	JRE
ISSUED FOR:	CO0/ I	
	00% 1	DESIGN SUBMISSION
DATE:	C	EDTEMBED 0000
	5	EPTEMBER 2023
DRAWING NA	ME:	

# LOW PRESSURE SEWER PLAN & PROFILES (NORWAY RD)


DRAWING NUMBER:

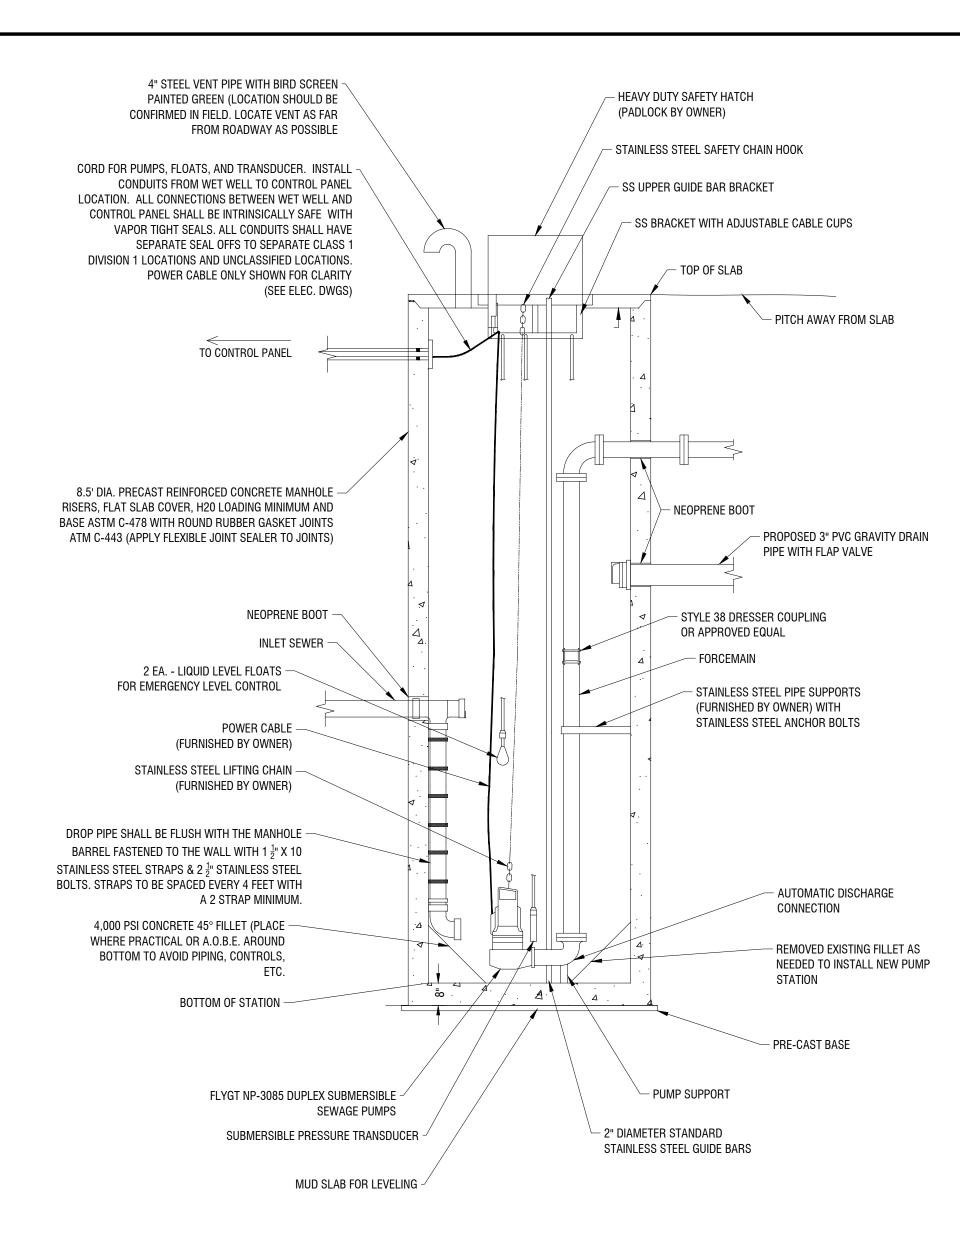

#### NOTES:

- 1. PUMP STATION IS DESIGNED SO THAT PUMPS OPERATE IN ALTERNATING FASHION. ONLY ONE PUMP IS TO OPERATE AT ANY ONE TIME. A SINGLE OPERATING PUMP HAS THE CAPACITY TO HANDLE PEAK FLOW CONDITIONS.
- 2. ALL PIPE OPENINGS THROUGH PUMP STATION, METER PIT AND VALVE VAULT WALLS SHALL BE SEALED WITH NEOPRENE BOOTS. PIPE OPENINGS SHALL BE 12" MIN. FROM MANHOLE JOINTS.
- 3. ALL PIPE FITTINGS WITHIN THE PUMP STATION AND VALVE VAULT SHALL HAVE FLANGED JOINTS AND ALL EXTERIOR PIPING SHALL HAVE MECHANICAL JOINTS.
- 4. ALL HARDWARE AND FASTENERS LOCATED IN WET WELL SHALL BE STAINLESS STEEL, #316 GRADE
- 4. COAT ENTIRE INTERIOR OF THE WET WELL WITH SIKAGUARD 62 OR APPROVED EQUAL. 5. ALL EXTERNAL SURFACES TO BE COATED WITH 2 COATS OF BITUMASTIC BLACK PAINT OR APPROVED
- 6. PROVIDE 2" ANNULAR GAP BETWEEN PIPE AND THE EXISTING WET WELL BASE.



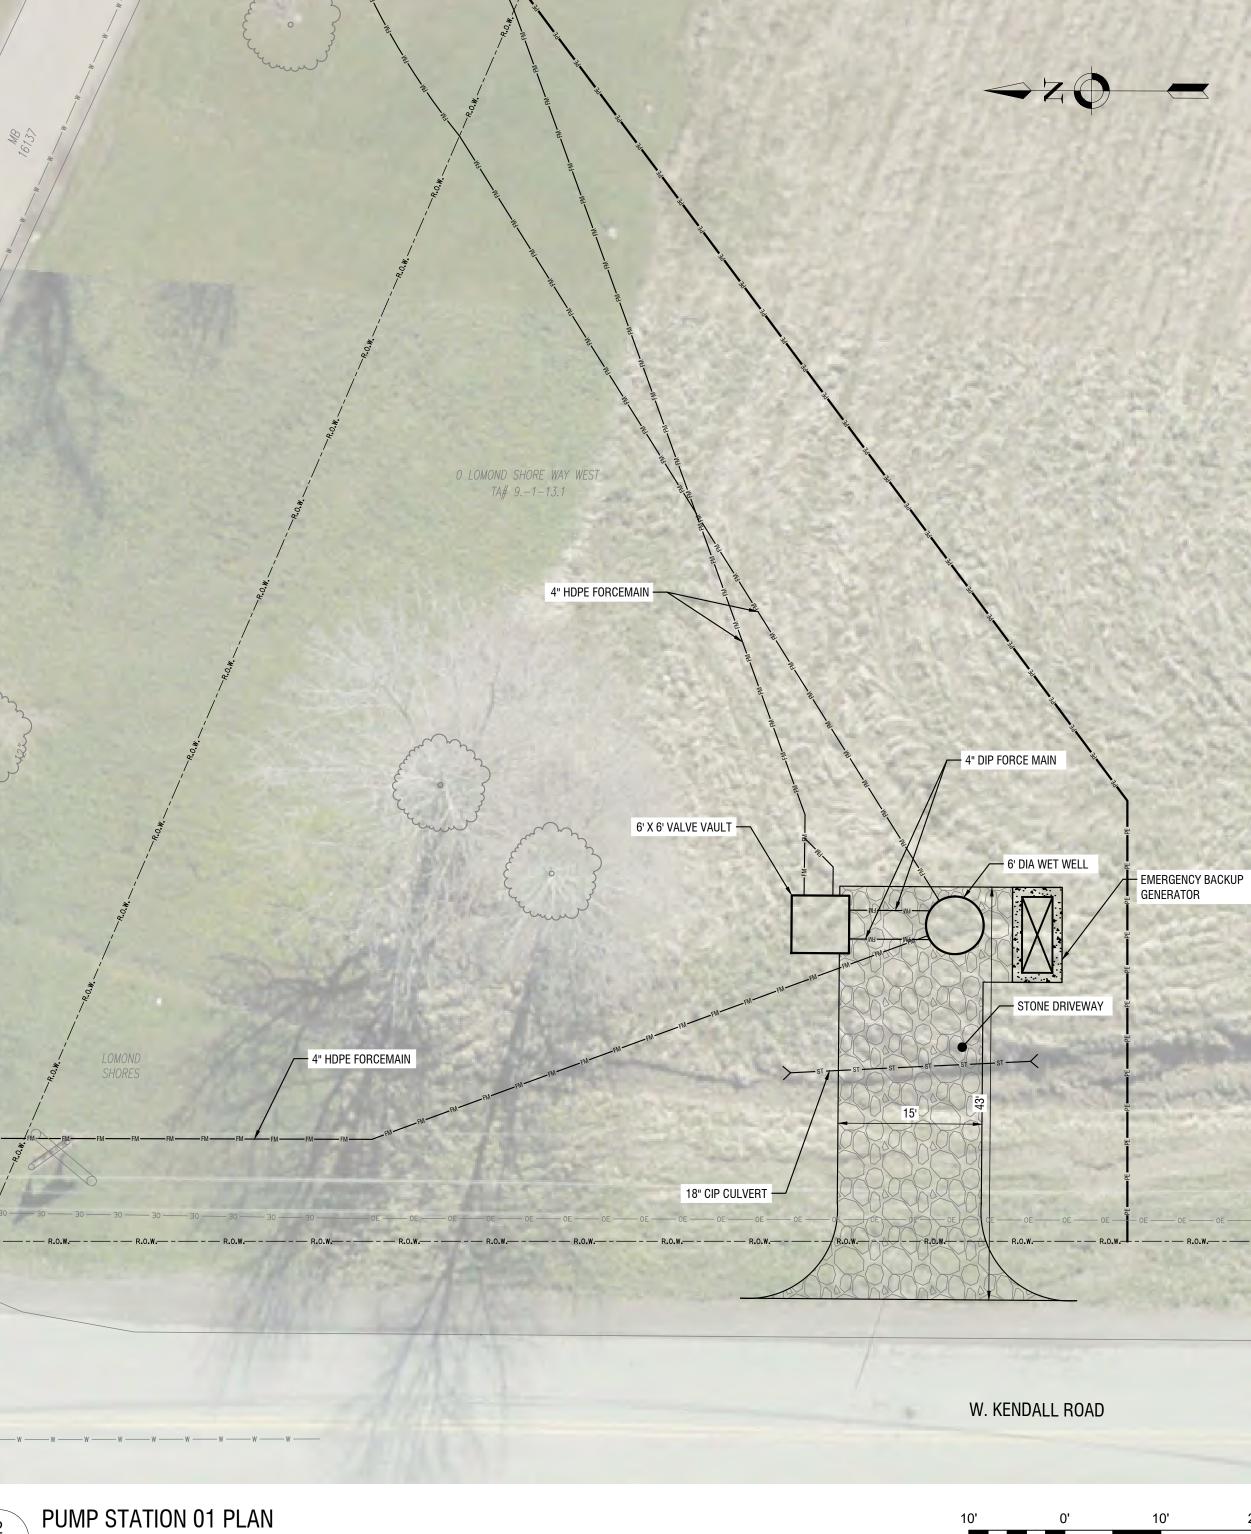


C401  $\int$  SCALE: 1" = 10'

SCALE 1" = 10'

Powered by partnership.

300 State Street, Suite 201 Rochester, NY 14614 585-454-6110

labellapc.com

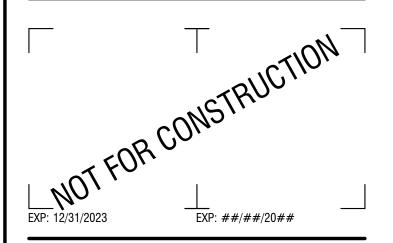

CERTIFICATE OF AUTHORIZATION NUMBER: PROFESSIONAL ENGINEERING: 095099 LAND SURVEYING: 017976 GEOLOGICAL: 018750

It is a violation of New York Education Law Art. 145 Sec. 7209 & Art. 147 Sec. 7307, for any person, unless acting under the direction of a licensed architect, professional engineer, or land surveyor, to alter an item in any way. If an item bearing the seal of an architect, engineer, or land surveyor is altered; the altering architect, engineer, or land surveyor shall affix to the item their seal and notation "altered by" followed by their signature and date of such alteration, and a specific description of the alteration.

© 2023 LaBella Associates



### **REDI WASTEWATER INFRASTRUCTURE** (CONTRACT 1)

TOWN OF KENDALL & TOWN OF HAMLIN

NO:	DATE:	DESCRIPTION:
Revisions		
ICVISIONS		
PROJECT		


2200455 JCB REVIEWED BY: JRE ISSUED FOR: 60% DESIGN SUBMISSION


DATE: SEPTEMBER 2023

DRAWING NAME:

PUMP STATION 01 **PLAN** (TOWN OF KENDALL)

DRAWING NUMBER:

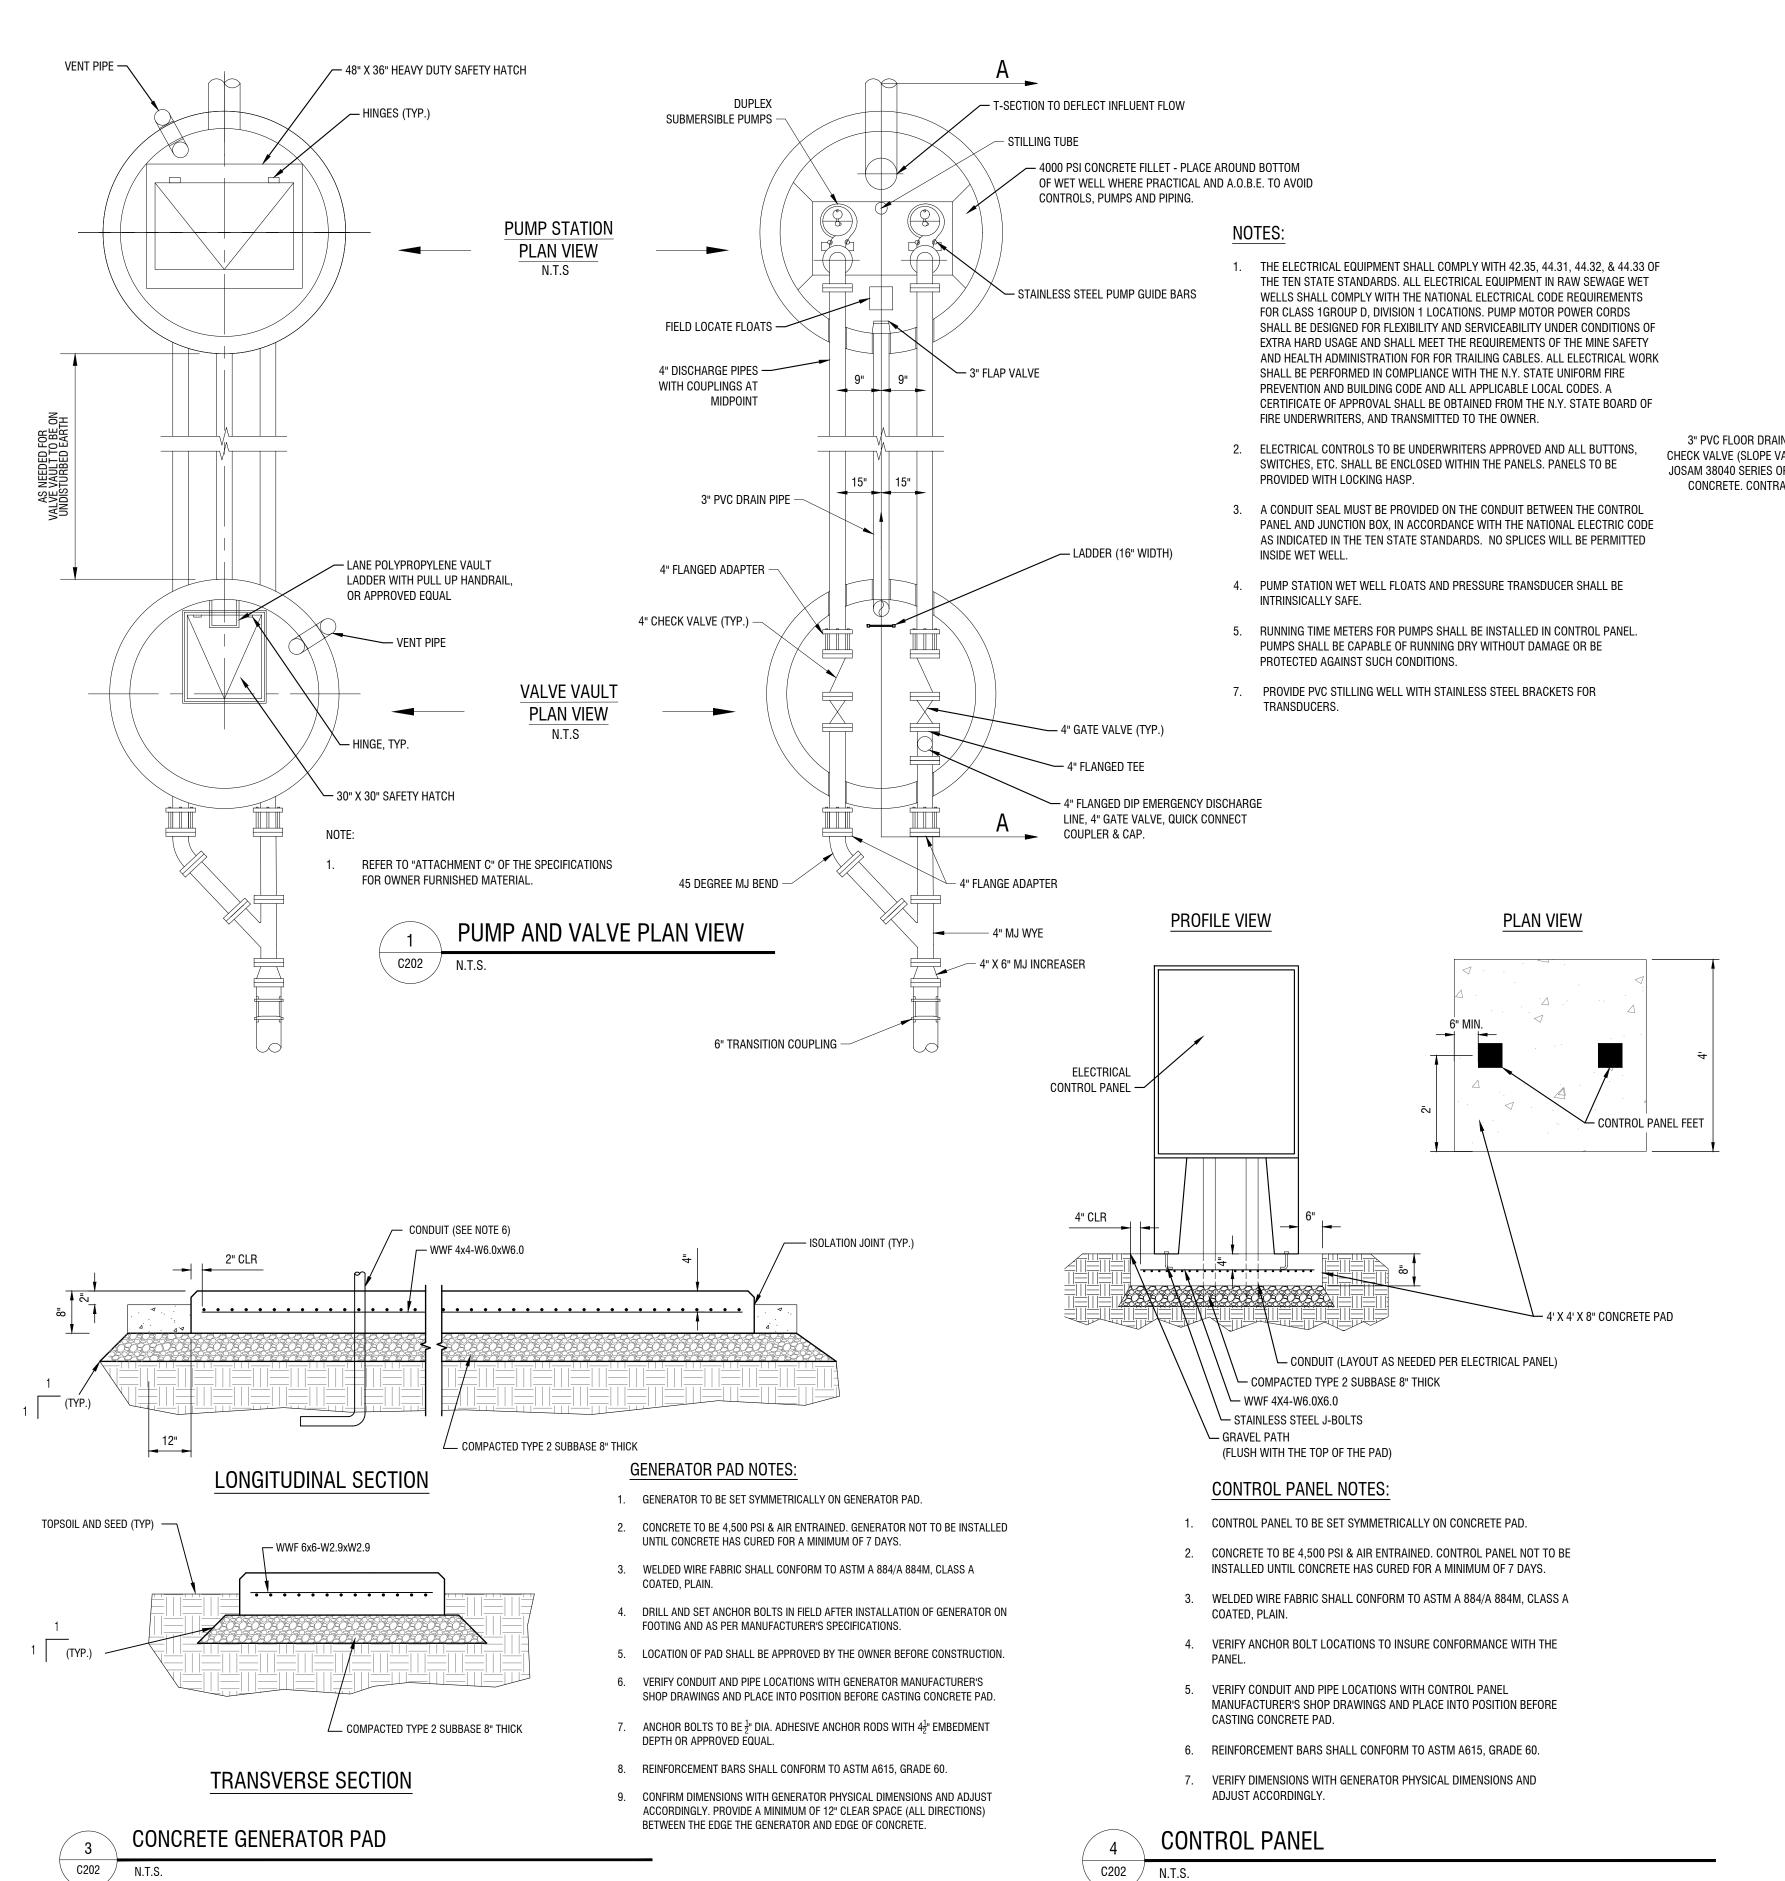

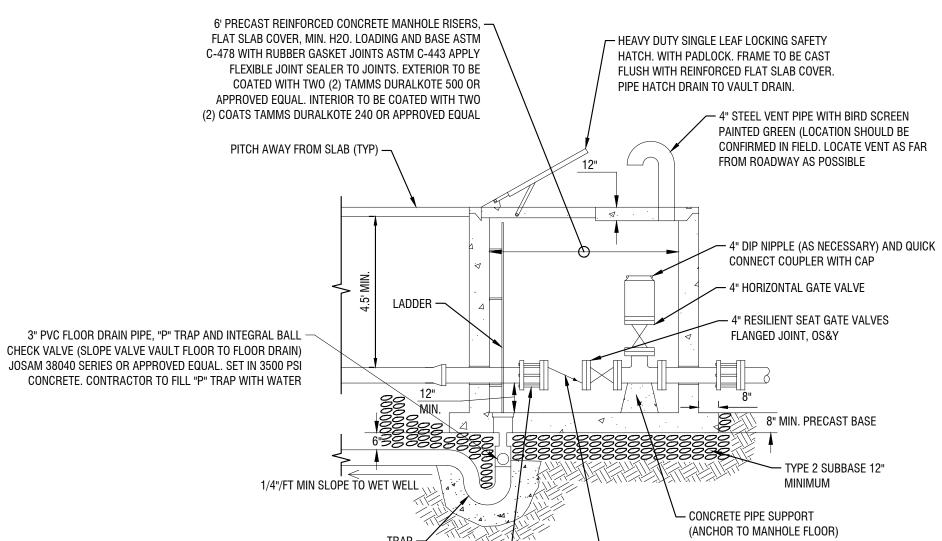


4" SWING CHECK VALVES FLANGED JOINTS



4" FLANGED ADAPTOR DRESSER

STYLE 13 OR APPROVED EQUAL

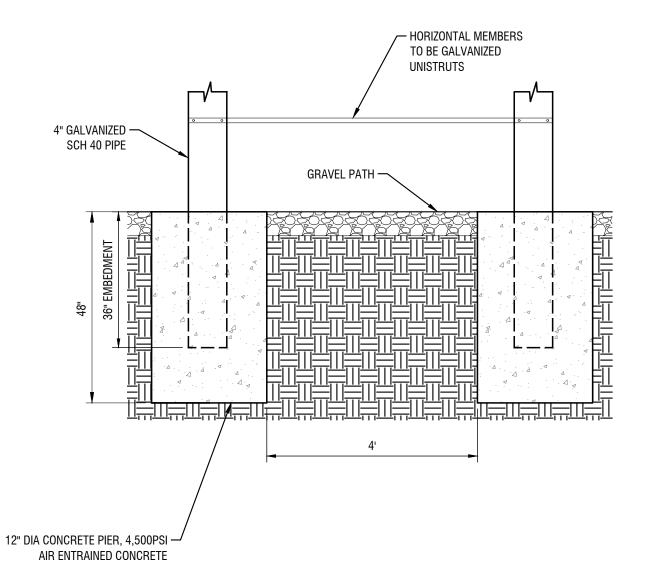

#### ELECTRICAL RACK FOUNDATION NOTES:


- 1. SECURELY FASTEN ALL PANELS.
- 2. ELECTRICAL COMPONENTS MAY NOT BE MOUNTED TO THE RACK UNTIL THE CONCRETE HAS CURED A MINIMUM OF 7 DAYS.
- 3. ALL ELECTRICAL COMPONENTS MUST BE A MINIMUM OF 30" & A MAXIMUM
- 72" ABOVE THE SURFACE.



#### **ELECTRIC RACK FOUNDATION**

300 State Street, Suite 201 Rochester, NY 14614 585-454-6110


labellapc.com

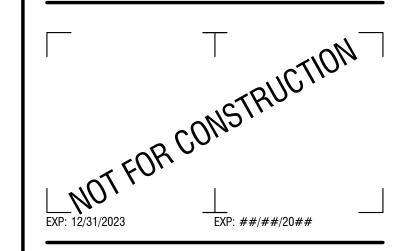

CERTIFICATE OF AUTHORIZATION NUMBER: PROFESSIONAL ENGINEERING: 095099 LAND SURVEYING: 017976 GEOLOGICAL: 018750

It is a violation of New York Education Law Art. 145 Sec. 7209 & Art. 147 Sec. 7307, for any person, unless acting under the direction of a licensed architect, professional engineer, or land surveyor, to alter an item in any way. If an item bearing the seal of an architect, engineer, or land surveyor is altered; the altering architect, engineer, or land surveyor shall affix to the item their seal and notation "altered by" followed by their signature and date of such alteration, and a specific description of the alteration.

© 2023 LaBella Associates

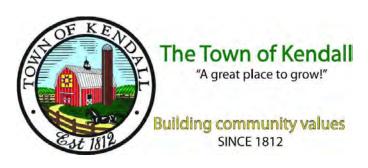

#### **REDI WASTEWATER INFRASTRUCTURE** (CONTRACT 1)

TOWN OF KENDALL & TOWN OF HAMLIN

PROJECT NUMB	ER: 2200455	
DRAWN BY:		
DEVIEWED DV	JCB	
REVIEWED BY:	JRE	
ISSUED FOR:	COO/ DECICAL CUDMICCION	
	60% DESIGN SUBMISSION	


DESCRIPTION:

NO: DATE:

PUMP STATION 01 **DETAILS** 

SEPTEMBER 2023

DRAWING NUMBER:

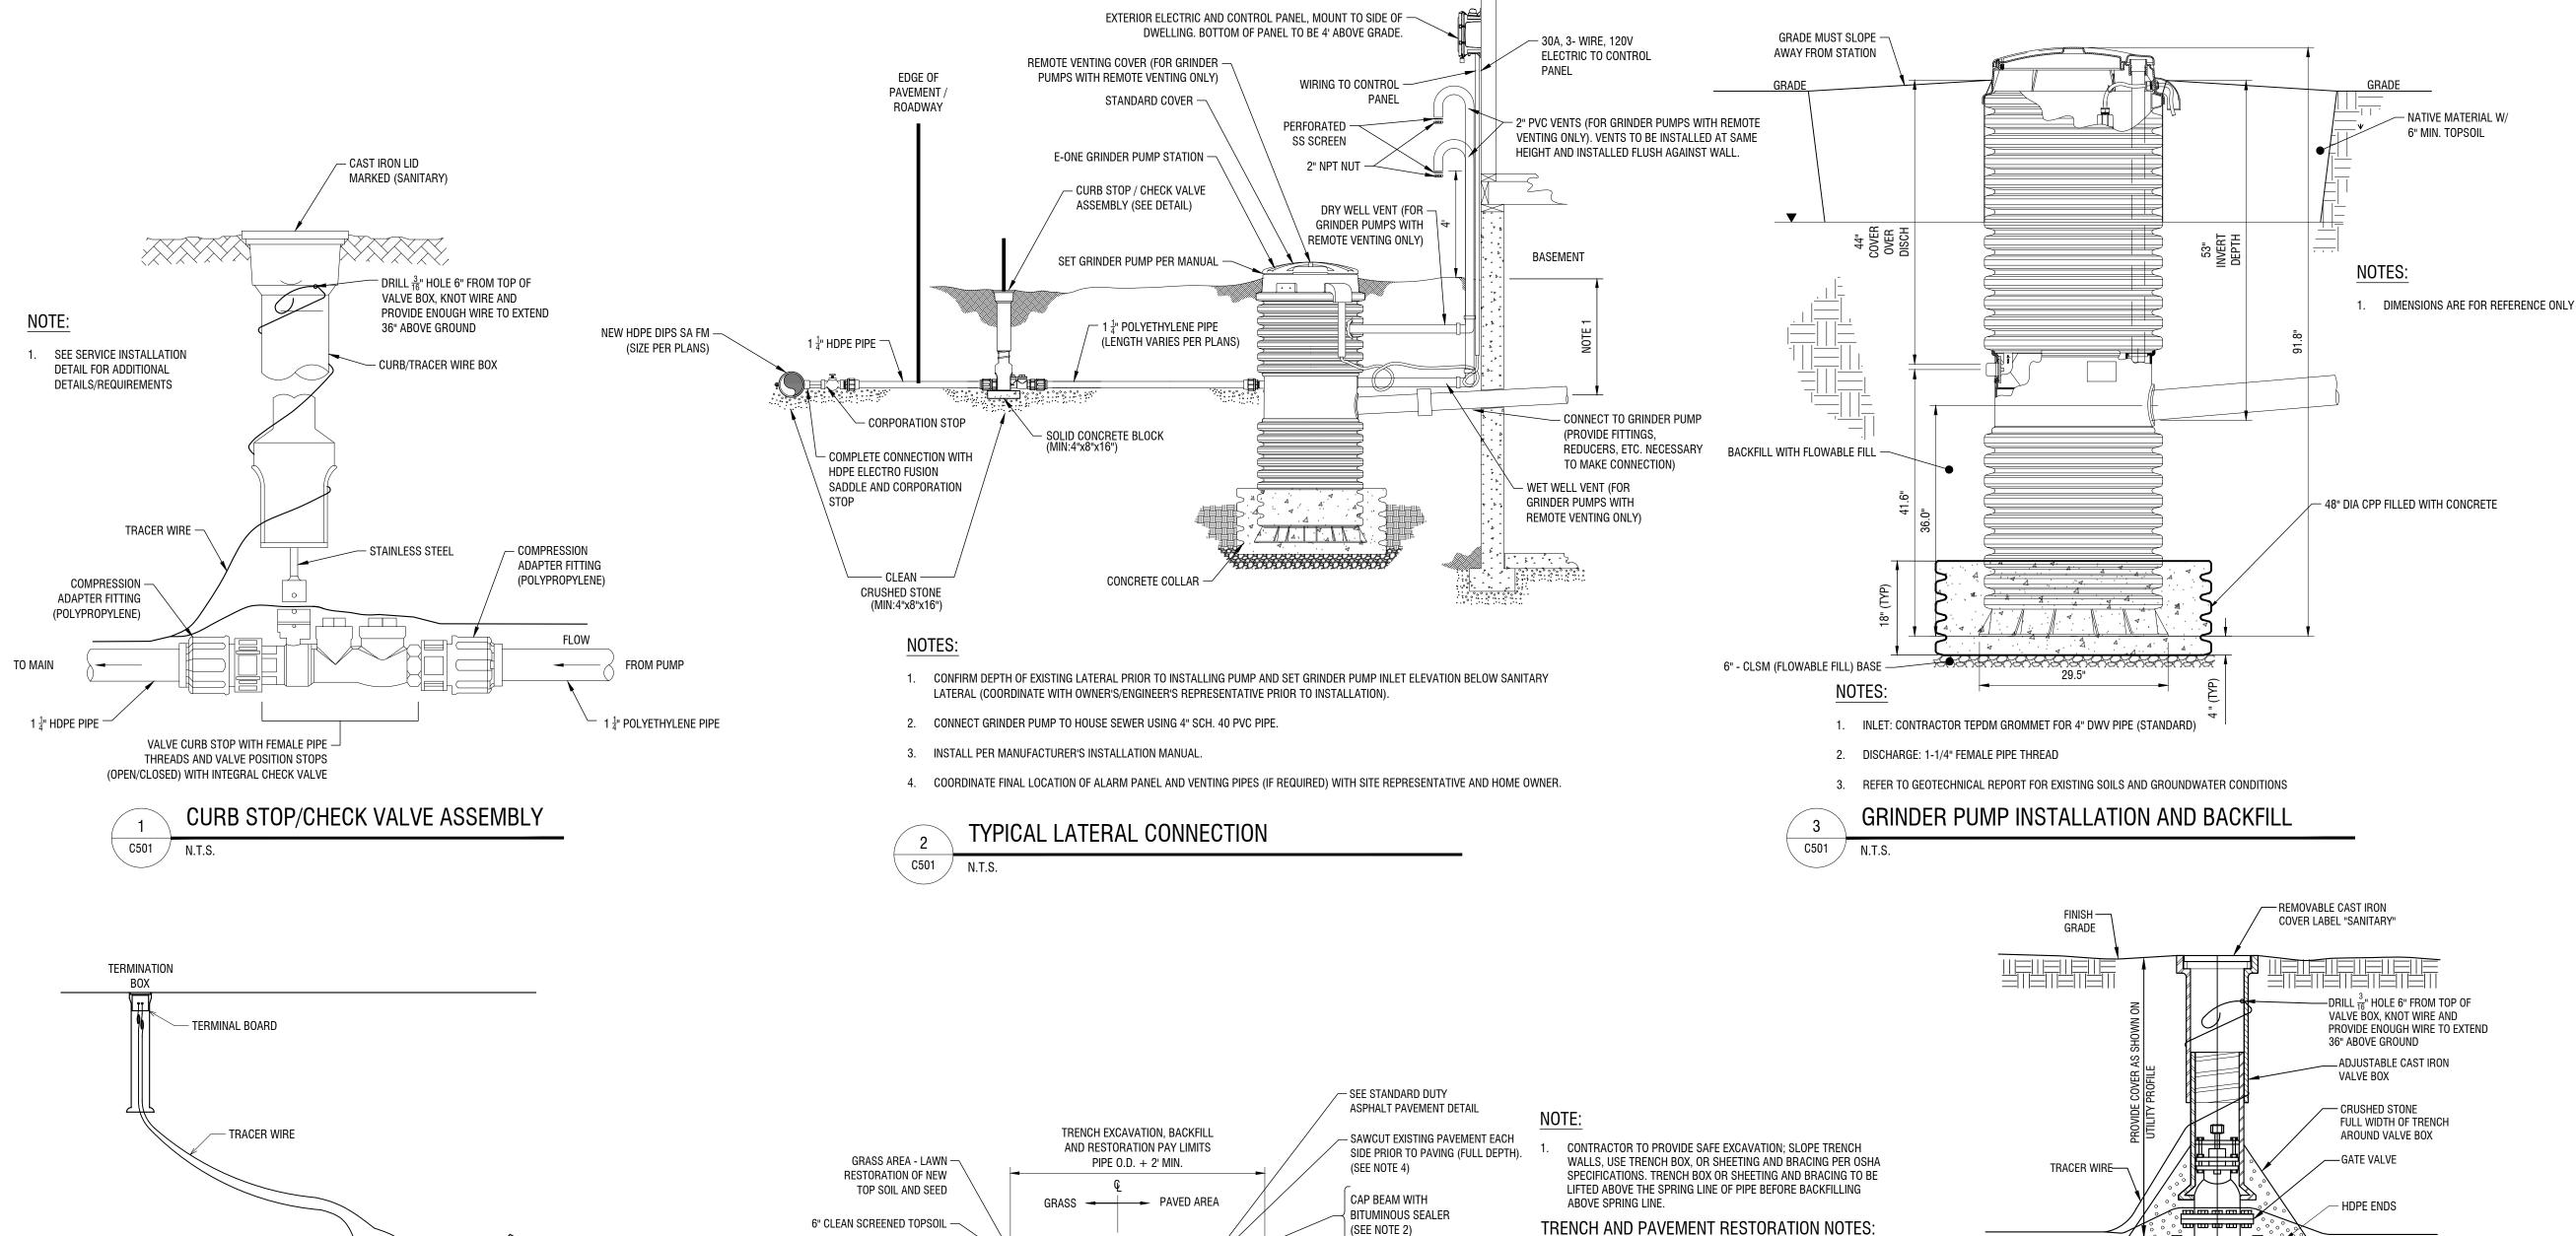

- EXISTING ASPHALT

PAVEMENT SECTION

- EXISTING PAVEMENT

- BACKFILL TO PAVEMENT

SECTION WITH SELECT

95% COMPACTION

CRUSHED STONE

GRANULAR FILL (NYSDOT

203-2.06) AND COMPACT TO

SUB BASE

WHEN NECESSARY, USE END TO END SPLICE
CONNECTOR FOR CONNECTING TRACER WIRE TO
FORCE MAIN TRACER WIRE ONLY.

FORCE MAIN PIPE

TAPE OR PLASTIC
STRAPS AT MAXIMUM

NOTES:

1. TRACER WIRE IS TO BE #12 AWG SOLID COPPER CLAD STEEL CORE WITH 45 MIL BLUE HDPE INSULATION. THOUGH NOT REQUIRED IT MAY BE PRUDENT TO INSTALL TWO TRACER WIRES IN DIRECTIONAL DRILLING APPLICATIONS.

6' INTERVALS

2. TRACER WIRE IS TO BE CONNECTED TO TERMINATION BOX INSTALLED. EXTEND TRACER WIRE UP INSIDE OF TERMINATION BOX LEAVING

MINIMUM OF 3 FEET OF TRACER WIRE COILED UP INSIDE TOP OF TERMINATION BOX. CONNECT END OF TRACER WIRE TO TERMINAL BOARD.

3. PROVIDE CONNECTIVITY TEST OF TRACER WIRE FOLLOWING INSTALLATION.

4 MA C501 N.T.S.

MAIN TRACER WIRE INSTALLATION

WARNING TAPE APPROXIMATELY

12" ABOVE MAIN

COMPACTED BACKFILL -

WITH NO AGGREGATE

LARGER THAN 3" SIZE

UNDISTURBED

EARTH OR ROCK

C501

SUITABLE NATIVE MATERIAL

SANITARY TRENCH EXCAVATION AND PAVEMENT RESTORATION

NEW PAVEMENT SECTION.

2. ALL SEAMS BETWEEN EXISTING AND NEW SURFACES ARE TO BE SEALED WITH AN ASPHALT FILLER CORRESPONDING TO THE MATERIAL REQUIREMENTS OF NYSDOT MATERIAL DESIGNATION 702-05 OR 702-3401.

BOTTOM OF ASPHALT BINDER COURSE SHALL MATCH THE BOTTOM OF OR BE SET BELOW BOTTOM OF THE EXISTING ASPHALT PAVEMENT

1. EXISTING PAVEMENT IS TO BE SAW CUT FULL DEPTH TO OBTAIN A

STRAIGHT AND NEAT EDGE FOR PAVING. SAW CUT IS TO BE MADE

PRIOR TO PAVING AFTER BACKFILLING THE TRENCH TO BOTTOM OF

- 4. SAW CUT 12" OUTSIDE INITIAL SAW CUT, PROVIDING A LEDGE OF UNDISTURBED SUBGRADE A MINIMUM OF 12" IN LENGTH.
- THE BITUMINOUS SURFACE COURSE SHALL BE 1.5 TIMES THE THICKNESS OF THE EXISTING PAVEMENT, A MINIMUM OF 4.5" INCLUDING A 1.5" TOP WEARING COURSE.
- WHERE THE THICKNESS OF THE EXISTING PAVEMENT EXCEEDS 4.5", THE DIFFERENCE BETWEEN THE 4.5" AND THE ACTUAL DIMENSION SHALL BE MADE UP WITH AN ASPHALT BASE COURSE.



2. PROVIDE STAINLESS STEEL BODY AND BONNET BOLTS.

1. CENTER VALVE BOX ON VALVE AND SET ON COMPACTED BACKFILL. VALVE MAY NOT

4. REFER TO PLANS AND SPECIFICATIONS FOR ADDITIONAL REQUIREMENTS.

SOLID CONCRETE BLOCK

(MIN 4"x8"x16")

1 REQUIRED

DIRECT WELDING FROM

HDPE PIPE TO GATE

VALVES HDPE ENDS -

UNDISTURBED -

SUPPORT VALVE BOX.

VALVES MUST OPEN LEFT.


EARTH

NOTES:

LaBella
Powered by partnership

300 State Street, Suite 201 Rochester, NY 14614 585-454-6110

labellapc.com

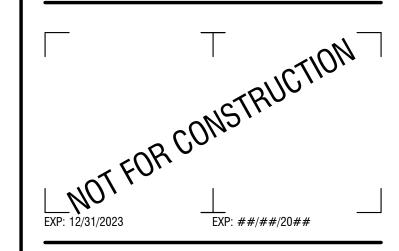

CERTIFICATE OF AUTHORIZATION NUMBER: PROFESSIONAL ENGINEERING: 095099 LAND SURVEYING: 017976 GEOLOGICAL: 018750

It is a violation of New York Education Law Art. 145 Sec. 7209 & Art. 147 Sec. 7307, for any person, unless acting under the direction of a licensed architect, professional engineer, or land surveyor, to alter an item in any way. If an item bearing the seal of an architect, engineer, or land surveyor is altered; the altering architect, engineer, or land surveyor shall affix to the item their seal and notation "altered by" followed by their signature and date of such alteration, and a specific description of the alteration.

© 2023 LaBella Associates



### REDI WASTEWATER INFRASTRUCTURE (CONTRACT 1)

TOWN OF KENDALL & TOWN OF HAMLIN

PROJECT NUMBER:

2200455

DRAWN BY: JCP

REVIEWED BY: JRE

DESCRIPTION:

ISSUED FOR: 60% DESIGN SUBMISSION

SEPTEMBER 2023

DRAWING NAME:


NO: DATE:


#### **CONSTRUCTION DETAILS**

DRAWING NUMBER:

#### MINIMUM MANHOLE DIAMETERS

# 0F					Р	IPE DIA	METER	RS			_
CONNECTIONS	8"	10"	12"	15"	16"	18"	21"	24"	30"	36"	42" & UP
ONE	4'	4'	4'	4'	4'	4'	4'	4'	5'	5'	
TW0	4'	4'	4'	4'	4'	4'	4'	4'	5'	5'	REQUIRES SPECIAL
THREE	4'	4'	4'	4'	4'	4'	5'	5'	5'	5'	MANHOLE
FOUR	4'	4'	4'	5'	5'	5'	5'	5'	5'	5'	

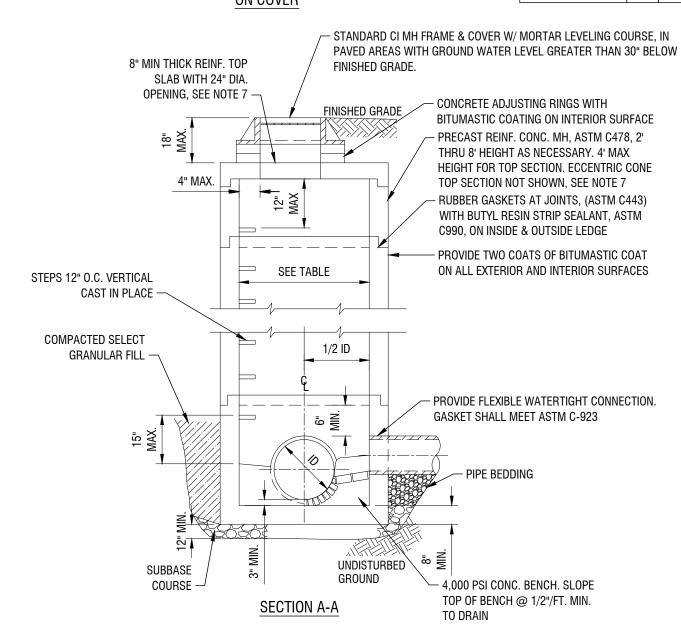

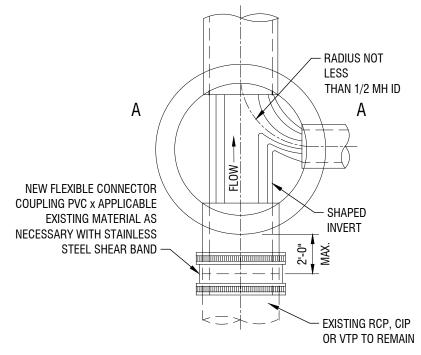


#### NOTES:

- 1. IF AN INVERT IS NOT GIVEN, THE CROWN OF THE INFLUENT SEWER(S) SHOULD BE AT THE SAME LEVEL OR ABOVE THE CROWN OF THE OUTLET SEWER.
- 2. PIPE CONNECTIONS 6" DIAMETER AND SMALLER MAY BE FIELD CORED. CORED OPENINGS IN MANHOLE RISER SECTIONS SHALL BE NOT LESS THAN 6" FROM A RISER JOINT.
- 3. ALL RISER JOINTS SHALL BE RUBBER RING GASKETS CONFORMING TO ASTM C443 WITH FLEXIBLE JOINT SEALER ON OUTSIDE OF JOINTS.
- 4. PRECAST BASES, RISER SECTIONS & TOP SLABS SHALL CONFORM WITH ASTM C478, W/ HS-20 LOADING AND 30% IMPACT LOADING DESIGN.
- 5. CONCRETE FOR STRUCTURE SHALL HAVE A MINIMUM 28 DAY COMPRESSIVE STRENGTH OF
- 6. INVERT AND BENCH MAY BE CONSTRUCTED WITH BRICK OR POURED CONCRETE. PVC AND/OR ABS PIPE SHALL NOT BE USED WITHIN THE MANHOLE.
- 7. ECCENTRIC CONE TYPE TOP SECTIONS FOR MANHOLES SHALL BE USED WHERE THE INSIDE HEIGHT DIMENSION FROM THE BENCH WALL TO THE BOTTOM OF THE ECCENTRIC SECTION EXCEEDS 8', OTHERWISE PROVIDE FLAT SLAB TOP SECTIONS.

SANITARY MANHOLE

C502 / N.T.S.

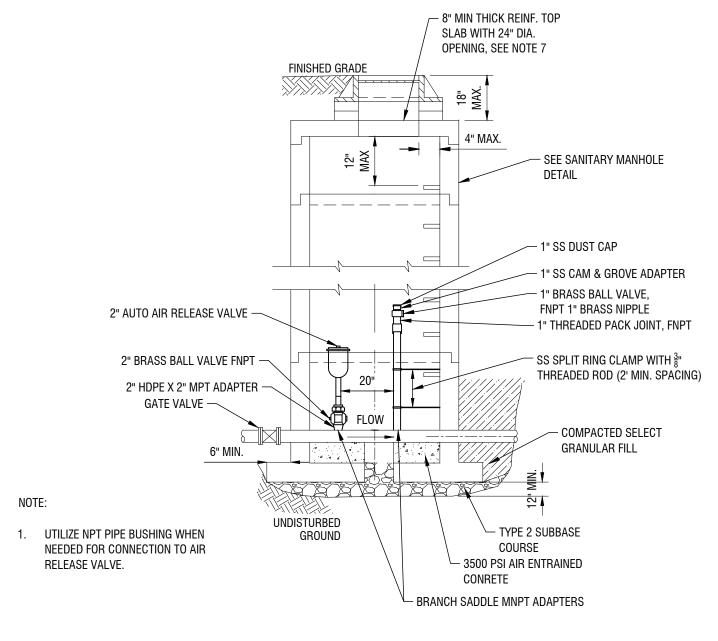

FLUSHING & AIR RELEASE MANHOLE

- — — — — — 1" SS DUST CAP -1" SS CAM & GROVE ADAPTER -1" BRASS BALL VALVE, -FNPT 1" BRASS NIPPLE 1" THREADED PACK JOINT, FNPT FLOW


NOTE:

C502


1. FOR PRE-CAST DETAILS SEE SANITARY MANHOLE DETAIL

BRANCH SADDLE MNPT ADAPTERS -


TERMINAL FLUSHING MANHOLE C502 / N.T.S.

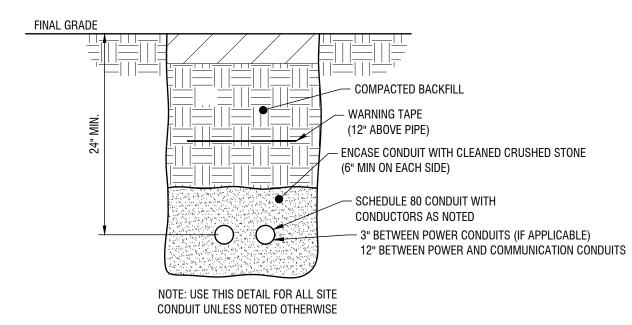

TYPICAL DIRECT BURY CONDUIT TRENCH DETAIL C502

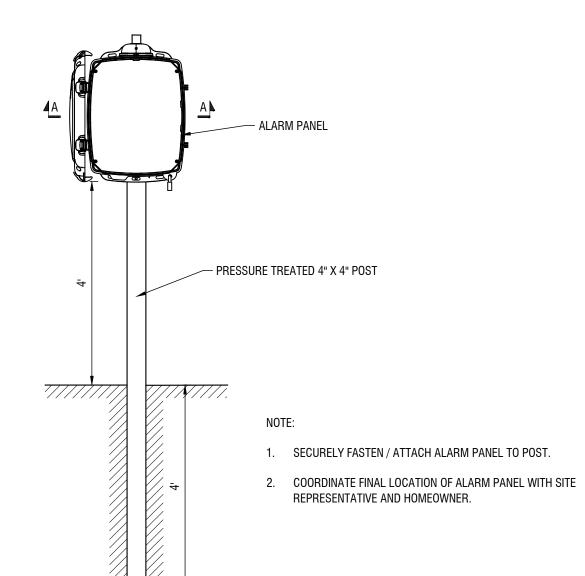



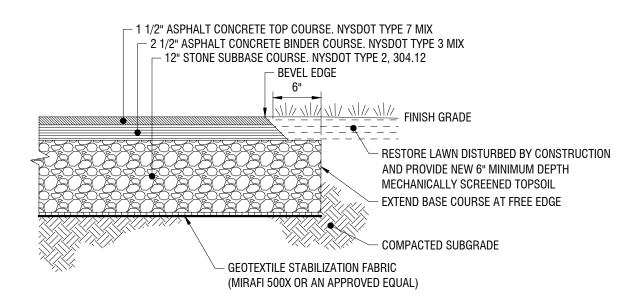


1. PROVIDE ADDITIONAL SUBBASE MATERIAL WHERE FILL IS REQUIRED TO OBTAIN PROPER SUBGRADE ELEVATION, OR TO REPLACE UNSUITABLE SUBGRADE MATERIAL.

C502 / N.T.S.

STANDARD DUTY ASPHALT PAVEMENT

300 State Street, Suite 201 Rochester, NY 14614 585-454-6110


labellapc.com

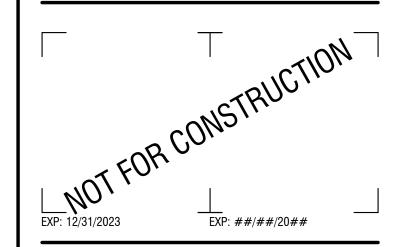

CERTIFICATE OF AUTHORIZATION NUMBER: PROFESSIONAL ENGINEERING: 095099 LAND SURVEYING: 017976 GEOLOGICAL: 018750

It is a violation of New York Education Law Art. 145 Sec. 7209 & Art. 147 Sec. 7307, for any person, unless acting under the direction of a licensed architect, professional engineer, or land surveyor, to alter an item in any way. If an item bearing the seal of an architect, engineer, or land surveyor is altered; the altering architect, engineer, or land surveyor shall affix to the item their seal and notation "altered by" followed by their signature and date of such alteration, and a specific description of the alteration.

© 2023 LaBella Associates

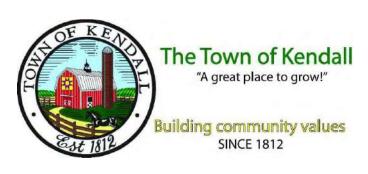

### **REDI WASTEWATER INFRASTRUCTURE** (CONTRACT 1)

TOWN OF KENDALL & TOWN OF HAMLIN

DESCRIPTION:

PROJECT NUME	BER: 2200455
DRAWN BY:	JCP
REVIEWED BY:	JRE

NO: DATE:

#### **CONSTRUCTION DETAILS**

SEPTEMBER 2023

DRAWING NUMBER:


WOVEN WIRE FENCE (MIN. 14 -

GAUGE W/ MAX. 6" MESH SPACING)

OR STAPLES. POSTS SHALL BE "T" OR "L" TYPE STEEL, OR 1.25" x 1.25" HARDWOOD. 2. FILTER CLOTH TO BE TO BE FASTENED SECURELY TO WOVEN WIRE FENCE WITH TIES SPACED EVERY 24" AT TOP AND MID SECTION. FENCE SHALL BE WOVEN WIRE, 14 GAUGE, 6" MAXIMUM MESH OPENING. 3. WHEN TWO SECTIONS OF FILTER CLOTH ADJOIN EACH OTHER THEY SHALL BE OVER-LAPPED BY SIX INCHES AND FOLDED. FILTER CLOTH SHALL BE MIRAFI 100X OR

APPROVED EQUIVALENT. 4. PREFABRICATED UNITS SHALL BE GEOFAB, ENVIROFENCE, OR APPROVED EQUIVALENT.

5. MAINTENANCE SHALL BE PERFORMED AS NEEDED AND MATERIAL REMOVED WHEN "BULGES" DEVELOP IN THE SILT FENCE.

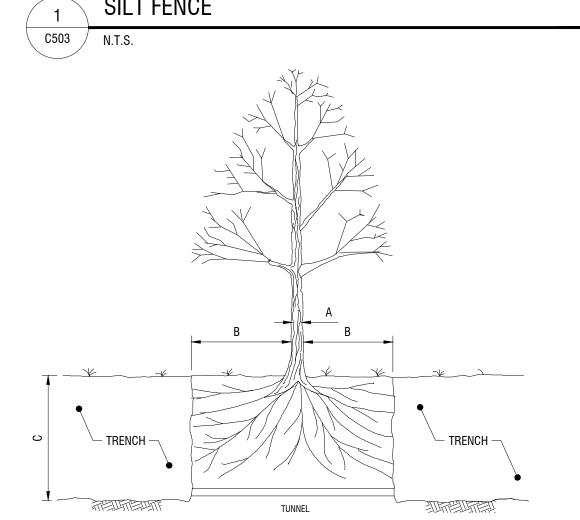


TREE DIAMETER "A" (DBH)	DISTANCE OF TUNNEL AND FENCING FROM FACE OF TREE TRUNK EACH SIDE "B"	RECOMMENDED MIN. DEPTH OF TUNNEL OR TRENCH "C"
LESS THAN 10"	6'	2 ½'
10" - 14"	10'	3'
15" - 19"	12'	3 ½'
20" OR MORE	15'	4'

- 1. OPEN TRENCH IN THE ROOT ZONE AREA OF A PUBLIC TREE IS PROHIBITED EXCEPT IN CASES WHERE THE TRENCHING FALLS OUTSIDE THE CANOPY OF THE TREE INVOLVED.
- 2. BEFORE COMMENCING WORK WITHIN THE TREE PROTECTION ZONE AUTHORIZATION IS REQUIRED FROM THE OWNERS REPRESENTATIVE.



#### UTILITY TRENCH AT EXISTING TREE



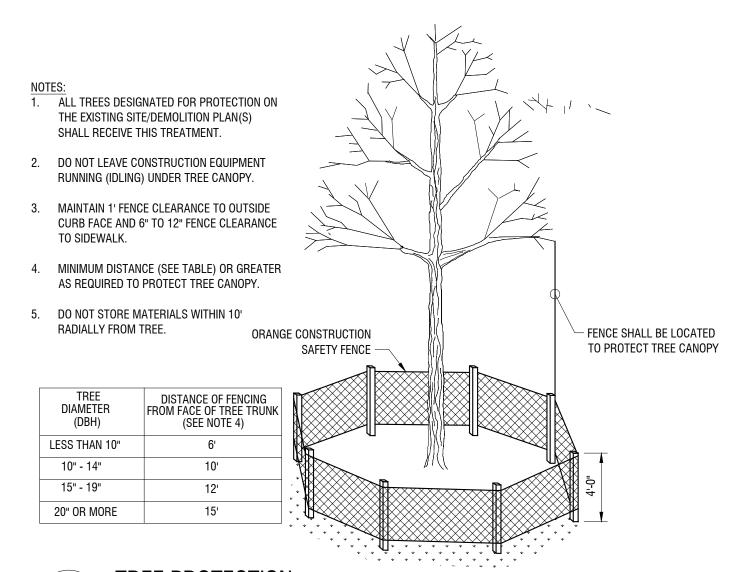

C503

STORM SEWER-GRATE

STORM SEWER GRATE-

C503 / N.T.S.

**INLET PROTECTION** 

CLEAN WATER -DISCHARGE HOSE GROUND WATER <u>▼</u> TABLE — SIDE SLOPE (OPTIONAL) 12" - 24" DIAMETER PERFORATED — PIPE WRAPPED ENTIRELY IN — CLEAN CRUSHED NON-WOVEN FILTER FABRIC STONE - PLACE NON-WOVEN FILTER FABRIC IN BOTTOM HALF OF SUMP

#### NOTES:

- 1. FILTER SOCK MUST COMPLY WITH NEW YORK STATE STANDARDS AND SPECIFICATIONS FOR EROSION AND SEDIMENT CONTROL.
- 2. PLACE COMPOST FILTER SOCKS ON THE CONTOUR WITH BOTH TERMINAL ENDS OF THE SOCK EXTENDED 8 FEET UPSLOPE AT A 45 DEGREE ANGLE TO PREVENT BYPASS

CONSTRUCTION SPECIFICATIONS

2. CONSTRUCT THE STANDPIPE WITH PERFERATED A 12-24" DIAMETER

3. PLACE STANDPIPE AFTER 12" STONE BASE COURSE HAS BEEN

4. THE STANDPIPE SHOULD EXTEND 12-18" ABOVE THE GRADE.

GROUND WATER FLOW INTO PERFORATED PIPE.

6. SUBMERSIBLE PUMP MAY ALSO BE USED/PLACED WITHIN

5. REMOVE & REPLACE FILTER FABRIC AS NECESSARY TO PERMIT

1. PIT DIMENSIONS TO BE DETERMINED IN FIELD.

CORRUGATED OR PVC PIPE.

INSTALLED..


- 3. DIAMETERS DESIGNED FOR USE MUST BE 12" -32".
- 4. THE FLAT DIMENSION OF THE SOCK MUST BE AT LEAST 1.5 TIMES THE NOMINAL DIAMETER.
- 5. THE MAXIMUM SLOPE LENGTH (IN FEET) ABOVE A COMPOST FILTER SOCK MAY NOT EXCEED THE FOLLOWING LIMITS:


DIA. (IN.)				SLOPE	%		
	Х	Х	Х	20	25	33	50
Х	250	225	125	65	50	40	25
18	275	250	150	70	55	45	30
24	350	275	200	130	100	60	35
32	450	325	275	150	120	75	50
*LENG	TH IN FEET	-					

- 6. USE WELL DECOMPOSED (MATURED AT LEAST 3 MONTHS), WEED-FREE, ORGANIC MATTER, COMPOST INFILL. COMPOST INFILL MUST BE AEROBICALLY COMPOSTED, POSSESS NO OBJECTIONABLE ODORS, AND CONTAIN LESS THAN 1% BY DRY WEIGHT, OF MAN-MADE FOREIGN MATTER. THE PHYSICAL PARAMETERS OF THE COMPOST MUST MEET THE STANDARDS LISTED IN TABLE 5.2-COMPOST STANDARDS TABLE.
- 7. ANCHOR COMPOST FILTER SOCKS IN EARTH WITH 2" X 2" WOODEN STAKES DRIVEN 12" INTO THE SOIL ON 10 FOOT CENTERS ON THE CENTERLINE OF THE SOCK. ON UNEVEN TERRAIN, EFFECTIVE GROUND CONTACT CAN BE ENHANCED BY THE PLACEMENT OF A FILLET OF FILTER MEDIA ON THE DISTURBED AREA SIDE OF THE COMPOST SOCK.

GROUND WATER

\_\_ 2" X 2" WOODEN STAKES PLACED 10' O.C. PLACE FILTER MEDIA — — BIODEGRADABLE COMPOST FILTER SOCK DISTURBED AREA UNDISTURBED VVVVV V SECTION VIEW

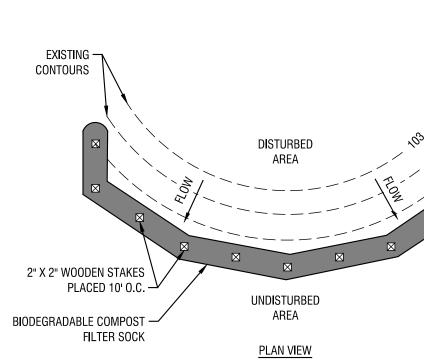

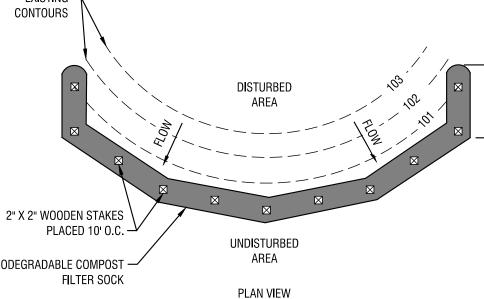

-FILTER SOCK FILLED WITH CRUSHED

STONE OR MULCH

SECURE FILTER SOCK


AS RECOMMENDED

BY MANUFACTURER

COMPOST FILTER SOCK

300 State Street, Suite 201 Rochester, NY 14614 585-454-6110


labellapc.com

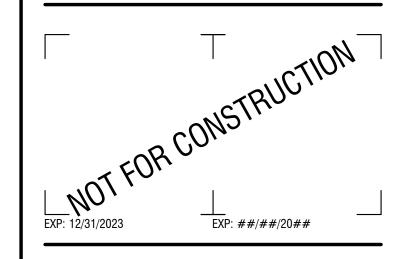

CERTIFICATE OF AUTHORIZATION NUMBER: PROFESSIONAL ENGINEERING: 095099 LAND SURVEYING: 017976 GEOLOGICAL: 018750

It is a violation of New York Education Law Art. 145 Sec. 7209 & Art. 147 Sec. 7307, for any person, unless acting under the direction of a licensed architect, professional engineer, or land surveyor, to alter an item in any way. If an item bearing the seal of an architect, engineer, or land surveyor is altered; the altering architect, engineer, or land surveyor shall affix to the item their seal and notation "altered by" followed by their signature and date of such alteration, and a specific description of the alteration.

© 2023 LaBella Associates

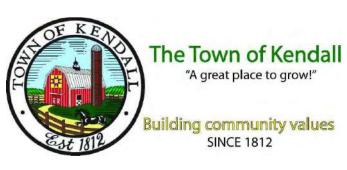

# **REDI WASTEWATER INFRASTRUCTURE** (CONTRACT 1)

TOWN OF KENDALL & TOWN OF HAMLIN

Revisions

REVIEWED BY: JRE

ISSUED FOR: 60% DESIGN SUBMISSION

DATE: SEPTEMBER 2023


DRAWING NAME:

**CONSTRUCTION DETAILS** 


DRAWING NUMBER:

**C503** 

NOTES:

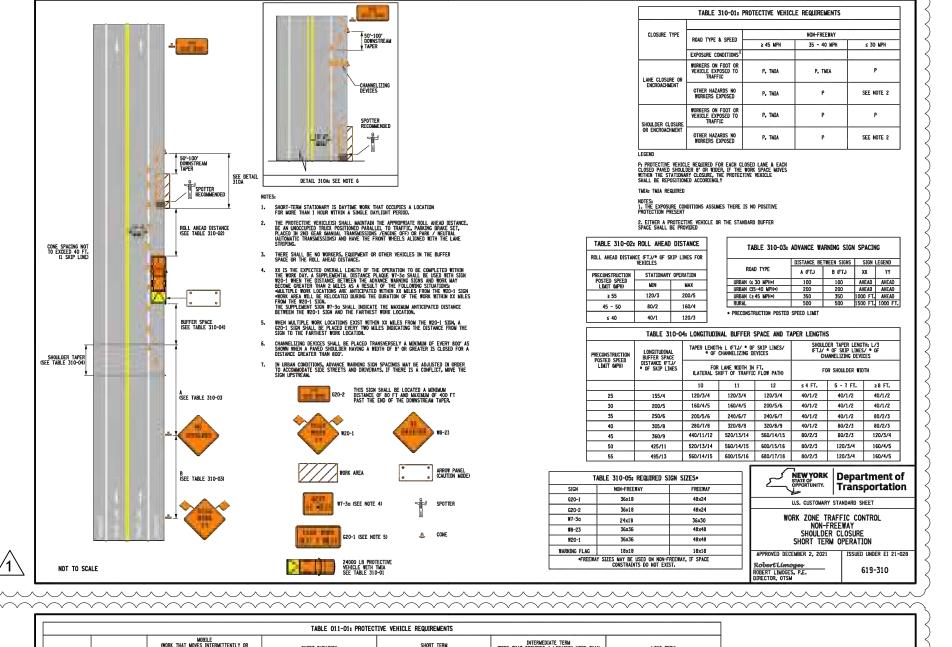


CLOSURE TYPE	DURATION	CONTINUOL	K THAT MOVE ISLY, WHERE TON COMPLET DES "STOP A	IOBILE S INTERMITTENT THE WORK AT AI ES WITHIN 15 M ND GO OPERATION S OR LESS	NY SPECIFIC INUTES) NS OF 5	(WORK THAT	SHORT DU OCCUPIES A L HOUR	OCATION FO		DAYTIME ! MORE THA	WORK THAT N 1 HOUR W	RT TERM OCCUPIES A LO ITHIN A SINGL ERIOD)	E DAYLIGHT	I ONE DAY	AT OCCUPIE LIGHT PERI R NIGHT TI	EDIATE TERM S A LOCATION M OD UP TO 3 CONS IME WORK LASTINI N 1 HOUR)	SECUTIVE G MORE	OWORK TH	AT OCCUPIE	IG TERM S A LOCATION F NSECUTIVE DAYS	'	-	1 SKIP LINE	1 SKIP LINE
	ROAD TYPE & SPEED	FREEWAY	45.45	NON-FREEW	,	FREEWAY	45 150 25	NON-FREEW		FREEWAY	. 45 1001	NON-FREE		FREEWAY	45.150	NON-FREEW		FREEWAY	45 450	NON-FREEW			30'	30'
	EXPOSURE CONDITIONS	1	≥ 45 MPH	35 - 40 MPH	≤ 30 MPH		45 MPH 35	- 4U MPH	≤ 30 MPH		≥ 45 MPH	35 - 40 MPH	1 ≤ 30 MPH	-	≥ 45 MPH	35 - 40 MPH	S 3U MPH		2 45 MPH	35 - 40 MPH	≤ 30 MPH		30"	30"
LANE CLOSURE OR	WORKERS ON FOOT OR VEHICLE EXPOSED TO TRAFFIC		P, TMIA	P, TMIA	Р	P. TMIA	P, TMIA	P, TMIA	Р	P, TMIA	P, TMIA	P, THEA	Р	P, TMIA	P, TMIA	P, TMEA	SEE NOTE 2	P, TMIA	P, TMIA	P, TMIA	SEE NOTE 2	10'	NORMAL BROKEN L	ANE LINE
ENCROACHMENT	OTHER HAZARDS NO WORKERS EXPOSED	NA	NA	NA	NA	P, TMIA	P, TMIA	P	Р	P, TMEA	P, TMIA	P	SEE NOTE 2	P, TMIA	P, TMEA	SEE NOTE 2	SEE NOTE 2	P, TMIA	P, TMIA	SEE NOTE 2	SEE NOTE 2		DETAIL 011A - SK	IP LINES
SHOULDER CLOSURE	WORKERS ON FOOT OR VEHICLE EXPOSED TO TRAFFIC	P. TMIA	P. TMIA	Р	P	P. TMIA	P. TMIA	Р	Р	P. TMEA	P. TMIA	Р	Р	P. TMIA	P. TMEA	SEE NOTE 2	SEE NOTE 2	P, TMIA	P, TMIA	SEE NOTE 2	SEE NOTE 2			
OR ENCROACHMENT	OTHER HAZARDS NO WORKERS EXPOSED	NA	NA	NA	NA	P, TMIA	P, TMIA	Р	Р	P, TMIA	P, TMIA	Р	SEE NOTE 2	P, TMIA	SEE NOTE 2	SEE NOTE 2	SEE NOTE 2	P, TMIA	SEE Note 2	SEE NOTE 2	SEE NOTE 2			
GEND PROTECTIVE VEHICL WORK SPACE MOV CORDINGLY IA: TRUCK/TRAILER NOT APPLICABLE	LE REQUIRED FOR EACH VES WITHIN THE STATIO I MOUNTED IMPACT ATTE	CLOSED LAN NARY CLOSUF INUATOR (TMI	IE & EACH CI E, THE PROTI	OSED PAVED SH ECTIVE VEHICLE	OULDER 8' OR SHALL BE RE	WIDER, IF POSITIONED									IOTES . THE EXPO . EITHER A	DSURE CONDITIONS A PROTECTIVE VE	S ASSUMES FICLE OR T	THERE IS NO HE STANDARD	POSITIVE I BUFFER SP	PROTECTION PRES ACE SHALL BE	SENT PROVIDED	SYMBOL	RK ZONE TRAFFIC CONT	
				TABLE 011-	02: TAPER	LENGTHS	k NUMBER (	OF CONES	CHART								ORK ZONE	TRAFFIC	CONTROL	1 EGEND		<u> </u> -	SIGN, TEMPORARY	
				TAPER LENGTH	ts L (FT.)/ * (	OF SKIP LIN	S/ * OF CHA	NNELIZING D	EVICES			SHOULDER (FT.)/ * 0	TAPER LENGT F SKIP LINES ELIZING DEVIC	H: L/3 / • 0F		SYMBOL	T ZONE		ESCRIPTION	LLOLINO			SPOTTER	
PRECONSTRUCTION POSTED SPEED LIMIT (MPH)	4	5	6	7	LATERAL SHIF	T OF TRAFF		(FT.)	11	T 40		FOR S	SHOULDER WID 5 - 7 FT.	тн		Ş	ARROW	PANEL					TEMPORARY POSITIVE BAR	RIER
25		/2/3	80/2/3	80/2/3	80/2/3	120/		0/3/4	120/3/4	120/3	-	10/1/2	40/1/2	≥8 FT. 40/1/2	+	:::	ARROW	PANEL, CAUT	ION MODE				TEMPORARY POSITIVE BAR	RIER WITH WARNING LIGHTS
30		/2/3	80/2/3	120/3/4	120/3/4	160/		0/4/5	160/4/5	200/5	_	10/1/2	40/1/2	40/1/2		888	ARROW	PANEL TRAIL	ER OR SUPF	PORT		®	TEMPORARY TRAFFIC SIGN	AL HEAD
35 40		0/3/4	120/3/4 160/4/5	160/4/5 200/5/6	160/4/5 240/6/7	200/	_	0/5/6	240/6/7 320/8/9	240/6 320/8	-	10/1/2	40/1/2 80/2/3	80/2/3 80/2/3	_	Н	CHANGE	EABLE MESSA	GE SIGN (PV	MS)		222	TYPE III BARRICADE	
45 50		0/6/7	280/7/8 320/8/9	320/8/9 360/9/10	360/9/10 400/10/11	_	_	_	520/13/14 560/14/15	560/14	_	80/2/3 80/2/3	80/2/3 120/3/4	120/3/4	_	-	CHANNE	ELIZING DEVI	Œ				WARNING LIGHTS	
55	240/6/7 280	8/1/0	320/8/9	400/10/11	440/11/12	_	_	-	600/15/16	680/17	-		120/3/4	160/4/5		A.	CONE						WORK AREA	
60 65		_	360/9/10 400/10/11	440/11/12	480/12/13 520/13/14		_		680/17/18 720/18/19	720/18	-		120/3/4	160/4/5	-	₩	CRASH	CUSHION/TEN	PORARY IMP	ACT ATTENUATO	1		WORK VEHICLE	
THIS TABLE WAS O	REATED WITH REFERENCE CHANNELIZING DEVICES	CE TO MUTCO SHOWN IS CA	TABLE 6H-4 LCULATED BA	480/12/13 SED ON A 40FT		800/1	716   640	/16/17	720/18/13	800/19	720   6	10/2/1	160/4/5	200/5/6	1	┕→	DIRECT	ION OF TEMP	ORARY TRAF	FIC DETOUR			WORK VEHICLE OMULCHING	/HERBICIDE OPERATION)
EVICE SPACING. THE	NUMBER OF CHANNELIZ	ING DEVICES	CAN BE ADJ	USTED AS NECE												-		ION OF TRAF				1 11	WORK VEHICLE (PAVEMENT	MARKING)
TABLE Longitudinal	011-03 BUFFER SPACE	1		04: ROLL AHE AHEAD DISTANCE				VEHICLES	$\dashv$		ADVANCE	TABLE 011 WARNING S	-06 Sign Spacin	IG			WITH C	ATED FLAGGEI PERATOR	ASSISTAM	CE DEVICE			WORK VEHICLE (SIGNAL W	
PRECONSTRUCTION POSTED SPEED LIMIT (MPH)	DISTANCE (FT.)/ * OF SKIP LINES	DDECON	STRUCTION	MOVING OF (BASED ON F VEHICLE SPEE	PROTECTIVE		STATIONARY	ODEDATION		ROAD TYP	E E	A (FT.) B (	TWEEN SIGNS FT.) C (FT.)		SEND YY	#	FLAGGE	ER			_	K-11		HICLE WITH TRUCK/TRAILER
25	155 / 4	POSTI	D SPEED T (MPH)	MIN	MAX		MIN	MAX		IAN (≤ 30 MI			00 100	AHEAD		<u> </u>	FLAG 1	TREE					24,000LB PROTECTIVE VE TRAILER MOUNTED ATTEN	HIGLE WITHOUT TRUCK/ JATOR
30 35	200 / 5 250 / 6	_	≥ 55	200/5	280/7		120/3	200/5		IAN (≥45 M		350 35	50 350 00 500	1000 FT.	AHEAD		LUMINA	AIRE				_		
40	305 / 8	-	- 50	160/4	240/6		80/2 40/1	160/4	FRE	EWAY	NI BOC==	1000 15	00 2640	1 MILE	/2 MILE	Ŧ	MOWER					5		Department of
45 50	360 / 9 425 / 11			REATED WITH RE		UTCD TABLE			PREC	S TABLE IS	THE SAME	SPEED LIMIT. AS MUTCO TAI	BLE NY6H-3.				PARKWA	AY GRASS SHO	DULDER				6	Transportation
55	495 / 13		F1 40		011-05	PADDICE				TA	TAI	BLE 011-07 TH FOR TE	MPORARY			11111	PAVEME REMOVE	ENT MARKINGS ED FOR A LOI	THAT SHAI IG TERM PR	L BE OJECT		-	U.S. CUSTOMARY S	TANDARD SHEET
65 THIS TABLE IS TH	645 / 16 E SAME AS MUTCD	$\vdash$		E RATES FOR		POSTED SPE			$\perp$		TRAFFIC	CONTROL Z	ZONES  TAPER LENG	TU (1)		PVMS	PORTA	BLE VARIABLE	MESSAGE S	SIGN			WORK ZONE TRA	FFIC CONTROL
ABLE 6C-2.		TEMPODA	TYPE OF PO	SITIVE BARRIER		40 50 MPH MPH	55 65 MPH MPH 16:1 20:1			ING TAPER ING TAPER	F TAPER	$\Rightarrow$	L /2	in (U		***	ADVANO WITH O	CE WARNING S DRANGE FLAGS	IGN				GENERAL TABLES	S AND LEGEND
				POST CORRUGATI					SHOUL ONE-L	DER TAPER	AY TRAFFIC		L/3 D FT. MIN -10 D FT. MIN -10			<u></u>	TRAILE	R FOR ARROW LE MESSAGE	PANEL OR SIGN (PVMS)	PORTABLE		Robert	/ED DECEMBER 2, 2021	ISSUED UNDER ET 21-03 619-011
										TABLE IS				v FI. MAX								ROBERT	LIMOGES, P.E.	013-011

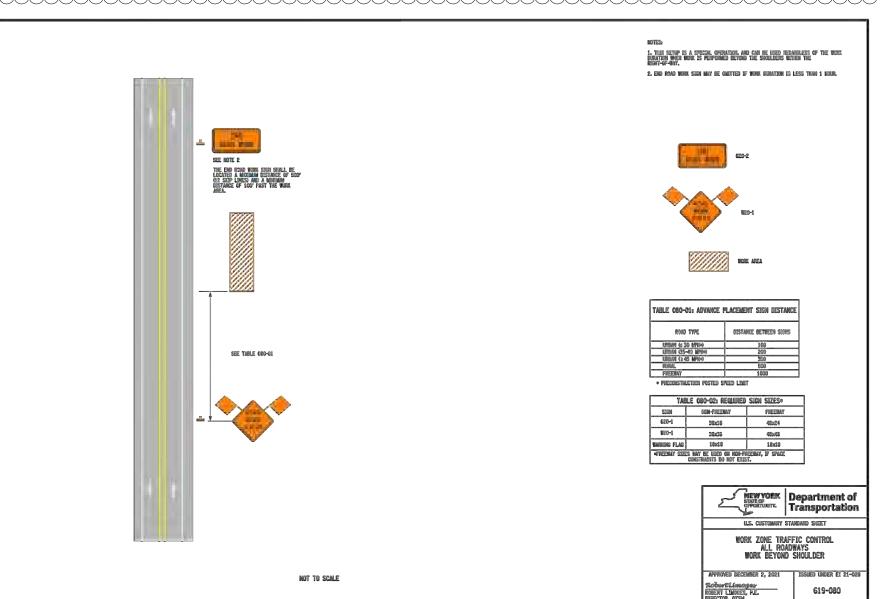



300 State Street, Suite 201 Rochester, NY 14614 585-454-6110


labellapc.com

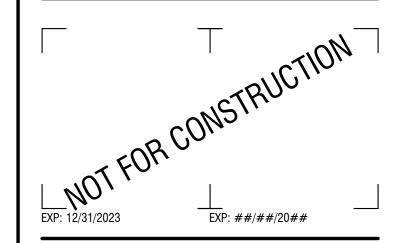

CERTIFICATE OF AUTHORIZATION NUMBER: PROFESSIONAL ENGINEERING: 095099 LAND SURVEYING: 017976 GEOLOGICAL: 018750

It is a violation of New York Education Law Art. 145 Sec. 7209 & Art. 147 Sec. 7307, for any person, unless acting under the direction of a licensed architect, professional engineer, or land surveyor, to alter an item in any way. If an item bearing the seal of an architect, engineer, or land surveyor is altered; the altering architect, engineer, or land surveyor shall affix to the item their seal and notation "altered by" followed by their signature and date of such alteration, and a specific description of the alteration.

© 2023 LaBella Associates

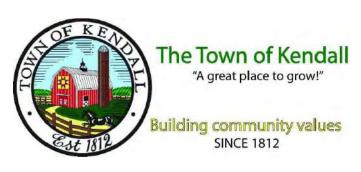


# REDI WASTEWATER INFRASTRUCTURE (CONTRACT 1)

TOWN OF KENDALL & TOWN OF HAMLIN


NO:	DATE:	DESCRIPTION:	
Revisions			
PROJECT N	IUMBER:	2200455	
DRAWN BY	<b>'</b> :	JCB	
REVIEWED	BY:	JUD	
		JRE	
ISSUED FO		DESIGN SUBMISSION	
DATE:	S	EPTEMBER 2023	
DRAWING	NAME:		

**MPOT PLAN** 

DRAWING NUMBER:

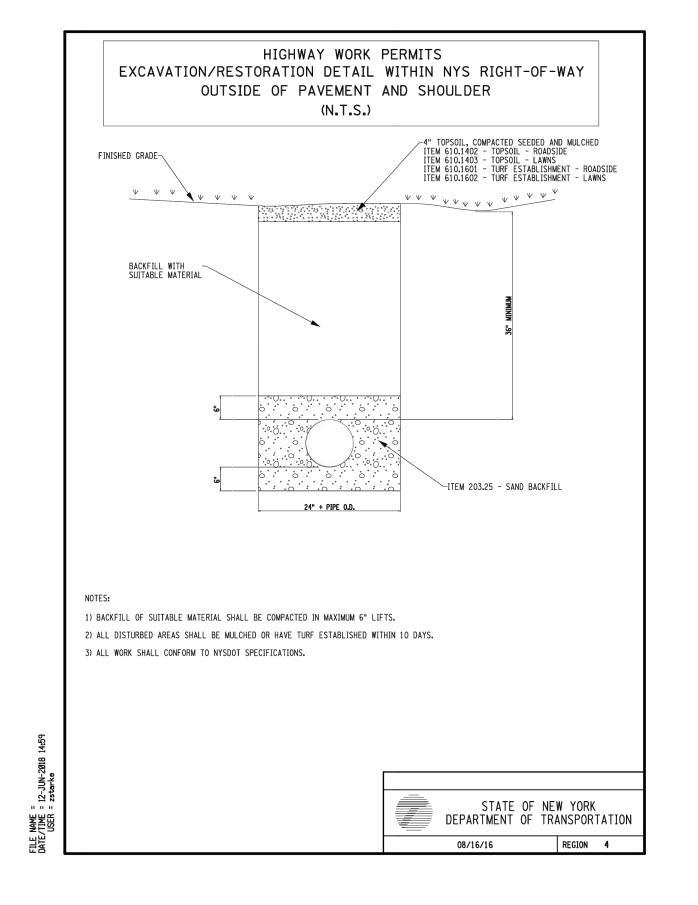

# EXCAVATION / RESTORATION DETAIL WITHIN NYS ROW OUT SIDE OF PAVEMENT & SHOULDER

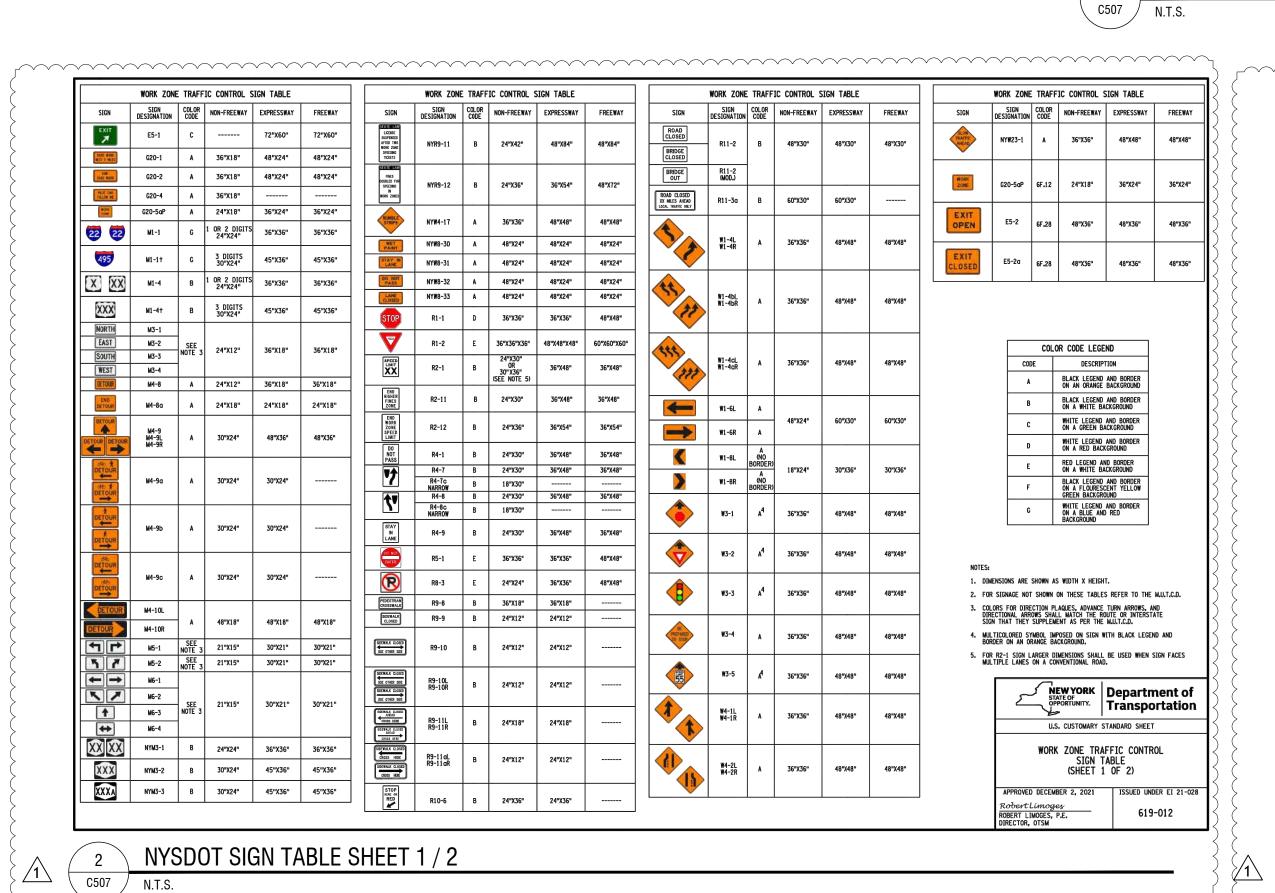


Y	VORK ZONE T	RAFFIC	CONTROL SIGN	N TABLE			WORK ZONE T	RAFFIC	CONTROL SIGN	N TABLE		y v	YORK ZONE TR	RAFFIC	CONTROL SIGN	I TABLE		
IGN	SIGN DESIGNATION	COLOR CODE	NON-FREEWAY	EXPRESSWAY	FREEWAY	SIGN	SIGN DESIGNATION	COLOR CODE	NON-FREEWAY	EXPRESSWAY	FREEWAY	SIGN	SIGN DESIGNATION	COLOR CODE	NON-FREEWAY	EXPRESSWAY	FREEWAY	1
OAD PROWS	W5-1	A	36"X36"	48"X48"	48"X48"	XX	W13-1P	A	24"X24"	30"X30"	30"X30"	i	W21-1	A	36"X36"	48"X48"	48"X48"	
AMP RIGHS	W5-4	   	36"X36"	48"X48"	48"X48"	ON RAMP	W13-4	A	36"X36"	36"X36"	36"X36"	R.						_
						NO PASSING ZONG	W13-4P	A	48"X48"X36"			SLOW MOVING VEHICLE	W21-4	A	36"X18"	48"X24"	48"X24"	_
<u> </u>	₩6-3	A .	36"X36"	48"X48"	48"X48"	500 FEET	W16-2P	A	24"X18"	30"X24"		SHILLDER	W21-5	A	36"X36"	48"X48"	48"X48"	
	₩7-3aP	A	24"X18"	36"X30"	36"X30"	NEXT 500 FT	W16-4P	SEE NOTE 3 A OR F	30"X24"									
IMP	W8-1	A	36"X36"	48"X48"	48"X48"	<b>←</b>	W16-5PL W16-5PR	A	24"X18"			MOUNTS SECULES	₩21-5aL ₩21-5aR	A	36"X36"	48"X48"	48"X48"	COLOR CODE LEGEND
EMENT	W8-3	A	36"X36"	48"X48"	48"X48"	K Y	W16-7PL W16-7PR	SEE NOTE 3 A OR F	24"X12"	30"X18"		anis anis	W21-5aR					CODE DESCRIPTION
						AHEAD	W16-9P	SEE NOTE 3 A OR F	24"X12"	30"X18"		1 cert						A BLACK LEGEND AND BORDER ON AN ORANGE BACKGROUND
VEL	W8-7	A	36"X36"	48"X48"	48"X48"	ADAB ADES ANTAD						SOLUTI SOLUTION TO SERVICE TO SER						B BLACK LEGEND AND BORDER ON A WHITE BACKGROUND
BUGH D A D	W8-8	A	36"X36"	48"X48"	48"X48"	ROAD MORE XXX FT MLE	W20-1	A	36"X36"	48"X48"	48"X48"	SHOULD'S SHOULD	W21-5bL W21-5bR	A	36"X36"	48"X48"	48"X48"	C WHITE LEGEND AND BORDER ON A GREEN BACKGROUND
							-					SIGN SHALER SHAL						D WHITE LEGEND AND BORDER ON A RED BACKGROUND RED LEGEND AND BORDER
LDER	W8-9	A	36"X36"	48"X48"	48"X48"	DETOUR DETOUR	W20-2	A	36"X36"	48"X48"	48"X48"							ON A WHITE BACKGROUND  BLACK LEGEND AND BORDER
TIER NE	W8-12	A	36"X36"			KOO FT I MLE	ļ					HONDIG	W21-8	A	36"X36"	48"X48"	48"X48"	F ON A FLOURESCENT YELLOW GREEN BACKGROUND WHITE LEGEND AND BORDER
						SCAD CLOSED AILTAD	W00.7	١.	2011V2011	401174011	40110/4011							G ON A BLUE AND RED BACKGROUND
LEN CHS	₩8-14	A	36"X36"	48"X48"	48"X48"	DOMO CLOSED CLOSED X MEE	W20-3	^	36"X36"	48"X48"	48"X48"	BLATING TOPE AHEAD	W22-1	A	36"X36"	48"X48"	48"X48"	
OVER	W8-15	A	36"X36"	48"X48"	48"X48"	OF LINE						ZOM ZOM J MILE						NOTES:
						Sie Lue See Lue Sin Lue	₩20-4	A	36"X36"	48"X48"	48"X48"	TURN OFF	W22-2	A	42"X36"	42"X36"	42"X36"	DIMENSIONS ARE SHOWN AS WIDTH X HEIGHT.     FOR SIGNAGE NOT SHOWN ON THESE TABLES REFER TO
	₩8-17	A	36"X36"	48"X48"	48"X48"							COLL Probat			1 10 100			THE M.U.T.C.D.  3. WHEN USED IN CONJUNCTION WITH A BICYCLE SIGN (W11-1) ( PEDESTRIAN CROSSING (W11-2) COLOR CODE SHALL MATCH.
ASER BUT	₩8-17p	A	24"X18"	30"X24"	30"X24"	LASE CLOSCO ANGAO LETT						BLASTING ZONE	₩22-3	A	42"X36"	42"X36"	42"X36"	TESESTICAL GIOSSING WITE EN GELON GOSE SINEE MATORIE
G LIEB	W8-23	A	36"X36"	48"X48"	48"X48"	CLUSED CLUSED I MEE	W20-5	A	36"X36"	48"X48"	48"X48"	SLOW THATEC ANDAO	W23-1	A	48"X24"	48"X24"	48"X24"	
TEL ON MENT	W8-24	A	36"X36"	48"X48"	48"X48"	SHEHT AHEAD SIGHT LANE CLOSED CLOSED	,					NEW						
						300 II MLE						PATTERH	₩23-2	A	36"X36"	48"X48"	48"X48"	
SED COM	W9-3	A	36"X36"	48"X48"	48"X48"	CLOSED ANENG 2							W24-1L					
(AR)	W11-1L+ W11-1R	A OR F	36"X36"	36"X36"		GLOSED TAME	W20-5a	A	36"X36"	48"X48"	48"X48"	<b>♦</b>	W24-1R	A	36"X36"	48"X48"	48"X48"	NEW YORK STATE OF OPPORTUNITY. Department of Transportation
$\sim$						TIGHT LAKES GLOSED HEAD Z HIGHT LAKES RIGHT LAKES						<b>A</b>	W24-1-1					U.S. CUSTOMARY STANDARD SHEET
(N)	₩11-2L• ₩11-2R	F	36"X36"	36"X36"		SCO FEETS I MILE						<b>(()</b>	W24-1aL W24-1aR	A	36"X36"	48"X48"	48"X48"	WORK ZONE TRAFFIC CONTROL
330	₩11-15L+ ₩11-15R	F	36"X36"	36"X36"			W20-7	A	36"X36"	48"X48"	48"X48"		WO A ALI					SIGN TABLE (SHEET 2 OF 2)
N NE	NYW5-32P•	A	24"X18"	24"X18"			L					<b>((() ())</b>	W24-1bL W24-1bR	A	36"X36"	48"X48"	48"X48"	APPROVED DECEMBER 2, 2021 ISSUED UNDER EI 21-0
	 W-GREEN BACKGR HIS SIGN PLAQUE	l	OR	1	I	I								I	1			Robert Limoges ROBERT LIMOGES, P.E. 619-012 DIRECTOR, OTSM

LaBella
Powered by partnership.

300 State Street, Suite 201 Rochester, NY 14614 585-454-6110

labellapc.com

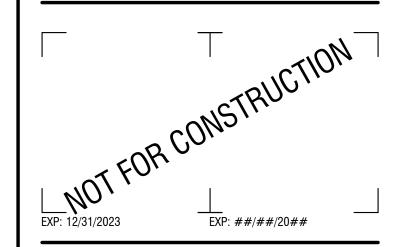

CERTIFICATE OF AUTHORIZATION NUMBER: PROFESSIONAL ENGINEERING: 095099 LAND SURVEYING: 017976 GEOLOGICAL: 018750

It is a violation of New York Education Law Art. 145 Sec. 7209 & Art. 147 Sec. 7307, for any person, unless acting under the direction of a licensed architect, professional engineer, or land surveyor, to alter an item in any way. If an item bearing the seal of an architect, engineer, or land surveyor is altered; the altering architect, engineer, or land surveyor shall affix to the item their seal and notation "altered by" followed by their signature and date of such alteration, and a specific description of the alteration.

© 2023 LaBella Associates



### REDI WASTEWATER INFRASTRUCTURE (CONTRACT 1)

TOWN OF KENDALL & TOWN OF HAMLIN

ER:	2200455
ER:	2200455
R:	2200455
	JCB
	JUD
	JRE
60% I	DESIGN SUBMISSION
S	EPTEMBER 2023

# **MPOT DETAILS**

DRAWING NUMBER:

- 2. ROADSIDE DRAINAGE TO BE MAINTAINED AT ALL TIMES.
- 3. MATERIALS, EQUIPMENT AND VEHICLES ARE NOT TO BE STORED OR PARKED WITHIN THE NEW YORK STATE RIGHT-OF-WAY.
- 4. MAINTENANCE AND PROTECTION OF TRAFFIC MUST COMPLY WITH THE CURRENT NATIONAL MUTCD WITH NYS SUPPLEMENT, SECTION 619 OF THE CURRENT NYSDOT STANDARD SPECIFICATIONS, THESE PLANS AND AS ORDERED BY THE ASSISTANT RESIDENT ENGINEER. ON A NYSDOT CONSTRUCTION PROJECT, MAINTENANCE AND PROTECTION OF TRAFFIC MUST COMPLY WITH THESE PLANS AND BE IN ACCORDANCE WITH THE NYSDOT CONTRACT DOCUMENTS AS DEEMED NECESSARY BY THE NYS ENGINEER-IN-CHARGE.
- 5. NOTIFY THE NEW YORK STATE DEPARTMENT OF TRANSPORTATION'S ASSISTANT RESIDENT ENGINEER AT THE APPROPRIATE NUMBER, AS NOTED BELOW, FIVE (5) WORK DAYS PRIOR TO WORKING WITHIN THE STATE RIGHT-OF-WAY.

#### ONTARIO CO. - GREG TROST (585) 396-4959

IN ADDITION, THE PERMITTEE SHALL NOTIFY NYSDOT REGIONAL TRAFFIC OPERATIONS CENTER (RTOC) OF ALL LANE AND SHOULDER CLOSURES AT LEAST THREE (3) DAYS IN ADVANCE OF THE PROPOSED WORK UTILIZING RTOC'S CONSTRUCTION NOTIFICATION FORM. RTOC'S CONTRUCTION NOTIFICATION FORM CAN BE OBTAINED FROM THE 511NY NOTIFICATION LINK AT THE WORK ZONE TRAFFIC CONTROL ICON ON THE REGION 4 PERMITS WEBSITE: WWW.DOT.NY.GOV/R4WORKPERMITS

PROPOSED CLOSURES WILL BE REVIEWED FOR CONCURRENT AND OVERLAPPING CLOSURE OR INCIDENT CONFLICTS AND WILL BE ENTERED INTO 511NY.ORG. CLOSURES INCLUDED IN THE NOTIFICATION SHALL CONFORM TO TIME, DATE, AND LOCATION RESTRICTIONS IN THE PERMIT RTOC MAY DISALLOW OR REDUCE CLOSURES DUE TO OTHER CLOSURES OR WORK, EVENTS, OR INCIDENTS FOUND IN CONFLICT WITH THE PROPOSED CLOSURE(S). ALL LANE AND SHOULDER CLOSURES SHALL BE REMOVED DURING NON-WORKING HOURS, EXCEPT WHERE AUTHORIZED BY THE NYSDOT REGIONAL TRAFFIC ENGINEER OR DESIGNEE.

- 6. NOTIFY THE NYSDOT TRAFFIC SIGNAL MAINTENANCE ENGINEER AT (585) 753-7793 5 DAYS PRIOR TO WORKING WITHIN 350' OF A SIGNALIZED INTERSECTION. NOTIFY DIG SAFELY NEW YORK 2 WORK DAYS PRIOR TO DIGGING, DRILLING OR BLASTING AT 811 FOR A UTILITY STAKE-OUT.
- WORK ZONE TRAFFIC CONTROL STANDARD SHEETS NOT INCLUDED IN THE PERMIT PACKAGE SHALL NOT BE UTILIZED UNLESS APPROVED BY THE REGIONAL TRAFFIC ENGINEER.
- 8. ALL MATERIALS USED WITHIN THE STATE RIGHT-OF-WAY MUST COMPLY WITH THE CURRENT NEW YORK STATE DEPARTMENT OF TRANSPORTATION SPECIFICATIONS ALONG WITH ANY APPROPRIATE CURRENT NYS DEPARTMENT OF TRANSPORTATION'S STANDARD SHEETS.
- 9. QUALITY CONTROL OF ASPHALT CONCRETE SHALL MEET THE REQUIREMENTS OF SECTION 401 OF THE STANDARD SPECIFICATIONS. ALL ASPHALT PRODUCED AS PART OF SECTION 401 WILL BE PAID AT A FINAL QUANTITY ADJUSTMENT FACTOR OF 1.0. ASPHALT COURSE DEPTHS SHOWN ON THE PLANS ARE COMPACTED DEPTHS.
- 10. NO NIGHT WORK SHALL BE ALLOWED UNLESS APPROVED PRIOR TO START OF PROJECT. ADDITIONAL MAINTENANCE AND PROTECTION OF TRAFFIC MAY BE REQUIRED INCLUDING THE ADDITION OF REFLECTIVE MATERIALS AND LIGHTING.
- 11. HAZARDOUS WASTE NOTIFICATION THE PERMITTEE ACCEPTS THE RIGHT-OF-WAY OF THE STATE HIGHWAY IN ITS "AS IS" CONDITION. THE DEPARTMENT OF TRANSPORTATION MAKES NO REPRESENTATION AS TO THE ABSENCE OF UNDERGROUND TANKS, STRUCTURES, FEATURES OR SIMILAR IMPEDIMENTS TO THE COMPLETION OF THE WORK PERMITTED HEREUNDER. SHOULD PERMITTEE FIND SOME PREVIOUSLY UNKNOWN UNDERGROUND IMPEDIMENTS TO ITS WORK, THE DEPARTMENT OF TRANSPORTATION SHALL HAVE NO OBLIGATION TO CURE, REMOVE, REMEDY OR OTHERWISE DEAL WITH SUCH PREVIOUSLY UNKNOWN UNDERGROUND IMPEDIMENTS. THE PERMITTEE IS REQUIRED TO REMOVE, MODIFY OR OTHERWISE DEAL WITH SUCH UNDERGROUND TANKS, STRUCTURES, FEATURES OR IMPEDIMENTS IN A MANNER WHICH MEETS ACCEPTABLE ENGINEERING PRACTICE AND IS APPROVED BY THE DEPARTMENT OF TRANSPORTATION.
- 12. ADA COMPLIANCE ALL WORK SHALL BE IN ACCORDANCE WITH THE AMERICANS DISABILITY ACT (ADA) AND THE REQUIREMENTS OF THE 2013 PROPOSED ACCESSIBILITY GUIDELINES FOR PEDESTRIAN FACILITIES (PROWAG). REFER TO STANDARD SHEET 608-01 FOR DETAILS
- 13. ANY DAMAGE TO ROADWAY FEATURES CASED DIRECTLY OR INDIRECTLY BY THE CONTRACTOR'S OPERATIONS WITHIN NYS ROW SHALL BE REPAIRED TO MEET NYSDOT STANDARDS AT THE CONTRACTOR'S EXPENSE.
- 14. NYSDOT OPERATIONS TAKE PRECEDENCE OVER HIGHWAY WORK PERMIT OPERATIONS. CONTRACTOR SHALL NOT HAVE WORK OPERATIONS IN PAVEMENT DURING INCLEMENT WEATHER CONDITIONS OR DURING SNOW AND ICE REMOVAL OPERATIONS ON STATE HIGHWAYS
- 15. FLAGGING OPERATIONS ARE NOT ALLOW 7 AM 7 PM, DUE TO HIGH VEHICLE VOLUME PER HOUR AT THIS LOCATION

#### NYSDOT REGION 4 EXCAVATION SUPPORT SYSTEM REQUIREMENTS

- 1. ANY EXCAVATION 5 FEET OR MORE IN DEPTH SHALL UTILIZE A SHIELDS AND SHORING OR A DESIGNED SHEETING SYSTEM AS DICTATED BY LOCAL SOIL CONDITIONS WHICH PROVIDES DIRECT CONTACT AND SUPPORT OF THE EXCAVATION SIDES. THE SYSTEM SHALL ACCOMMODATE ANY ASSOCIATED SURCHARGE LOADS AND SHALL BE SUBMITTED TO NYSDOT'S REGIONAL GEOTECHNICAL ENGINEER FOR REVIEW AND APPROVAL PRIOR TO PERMIT ISSUANCE.
- 2. A SLOPING (LAYBACK) OPTION WILL NOT BE ALLOWED.
- 3. SHIELDS AND SHORING OR SHEETING SYSTEM REQUIREMENTS DO NOT PERTAIN TO TEST PITS WHICH ARE 18" OR LESS IN DIAMETER.
- 4. SHORING SYSTEM REQUIREMENTS:
- A PRE-ENGINEERED/MANUFACTURED SHORING SYSTEM DOES NOT REQUIRE A PE STAMP AS LONG AS THE CUT SHEETS SHOW WHAT THE SHORING SYSTEM IS RATED FOR IN EACH SOIL TYPE AND THAT INFORMATION IS AVAILABLE FOR PUBLIC VIEWING (IT IS READILY AVAILABLE FOR ANYONE TO LOOK AT). THE MANUFACTURER IS BASICALLY LIABLE FOR IT.
- A DESIGNED SHORING SYSTEM, A SYSTEM DESIGNED BY AN ENGINEER, MUST BE STAMPED BY A NYS PE.

#### GENERAL NOTES FOR TRENCHING AND BORING AROUND TRESS

- 1. WHEN THE EDGE OF TRENCH IS WITHIN 10 FEET OF ANY TREE OR SHRUB, TEMPORARY PLASTIC BARRIER FENCE SHALL BE INSTALLED TO PROVIDE TREE OR SHRUB WITH THE MAXIMUM AREA OF PROTECTION POSSIBLE.
- 2. WHEN TRENCHING NEXT TO ANY TREE, AND ROOTS 2 INCHES OR LARGER MUST BE CUT, SHOVEL BY HAND NEAR THE ROOTS AND SAW THE ROOTS. ACCIDENTALLY BROKEN ROOTS SHOULD BE SAWED 2 INCHES BEHIND THE BROKEN END.
- 3. WHEN TRENCHING NEXT TO ANY TREE OR SHRUB, DO NOT PILE SOIL BETWEEN THE TRENCH AND THE TREE OR SHRUB. PLACE SOIL ON THE FAR SIDE OF THE TRENCH FROM THE TREE. WHEN THIS IS NOT POSSIBLE, PLACE SOIL ON PLYWOOD, A TARP OR A 2 INCH
- 4. FOR TREES WITH A 3 TO 6 INCH DIAMETER BREAST HEIGHT (DBH), TRENCHING SHALL COME NO CLOSER TO THE TREE THAN THE DRIPLINE. IF THE DRIPLINE OF THE TREE CANNOT BE AVOIDED THEN BORING SHALL OCCUR. BORING SHALL BEGIN AND END A MINIMUM OF 5 FEET FROM BOTH SIDES OF THE TREE.
- 5. THE UTILITY LINE SHALL BE BORED WHEN TREES WITH A 6 INCH OR LARGER DBH ARE WITHIN 12 FEET OF THE PROPOSED UTILITY. THE MINIMUM DISTANCE OF BORING FROM BOTH SIDES OF THE TREE IS DETERMINED BY THE DBH OF TREE, AS SPECIFIED IN THE

	TRENCHING SHALL BE
	REPLACED BY BORING
WHEN DB OF TREE IS:	AT THIS MINIMUM
	DISTANCE FROM BOTH
	SIDES OF THE TREE:
6-9 INCHES	5 FEET
10-14 INCHES	10 FEET
15-19 INCHES	12 FEET
OVER 19 INCHES	15 FEET

6. WHEN BORING UNDER TREES, THE BORE SHALL BE A MINIMUM OF 3 FEET DEEP UTILIZING THE TABLE ABOVE, A TREE THAT HAS A 12 INCH DBH, THE BORING WOULD START

AT LEAST 10 FEET BEFORE THE TREE TRUNK AND END AT LEAST 10 FEET AFTER THE TREE

#### NYSDOT REGION 4 UTILITY PERMIT NOTES

- ROAD PAVEMENT, SHOULDER AND DRAINAGE ARE NOT TO BE DISTURBED OR UNDERMINED UNLESS INDICATED OTHERWISE IN THE PLANS.
- 2. SUITABLE NON-FROZEN, NON SATURATED BACKFILL TO BE USED AND PLACED IN 6" COMPACTED LIFTS.
- 3. PAVEMENT TO BE MAINTAINED UNTIL A PERMANENT REPAIR CAN BE MADE.
- 4. PAVEMENT TO BE REPLACED IN KIND OR AS SPECIFIED ON ATTACHED PLANS.
- 5. ALL DISTURBED GRASS AREAS WITHIN THE R.O.W. ARE TO BE FINE GRADED, 4" TOPSOIL PLACED AND TURF ESTABLISHED

ROAD PLATES SHALL NOT BE USED DURING THE ASNOW AND ICE SEASON@ (NOVEMBER 1ST THROUGH APRIL 1ST). DURING THE MONTHS OF OCTOBER AND APRIL, CALL THE WORK AREA JURISDICTIONAL N.Y.S.D.O.T. TRANSPORTATION MAINTENANCE RESIDENCY WITH PLATE LOCATIONS. ROAD PLATES SHALL BE PINNED AND RAMPED. A "STEEL PLATE AHEAD" SIGN (W8-24) SHALL BE INSTALLED IN ADVANCE OF THE PLATE IN ACCORDANCE WITH TABLE NY6H-3 ON STANDARD SHEET 619-11. IF THE SURFACE OF THE PLATE IS 1" OR GREATER ABOVE/BELOW THE SURROUNDING PAVEMENT, A "BUMP" SIGN (W8-1) SHALL BE INSTALLED BETWEEN THE PLATE AND "STEEL PLATE AHEAD" SIGN IN ACCORDANCE WITH TABLE NY6H-3 ON STANDARD SHEET 619-11 AND A BARREL WITH A TYPE A FLASHER SHALL BE PLACED ON THE SHOULDER AT THE PLATE.

#### WINTER ASPHALT PAVEMENT AND SHOULDER RESTORATION

- EXCAVATION BACKFILL SHALL BE WITH NO. 2 STONE (NOT CRUSHER RUN), ITEM 623.12 PLACED TO SIX INCHES (6") BELOW THE EXISTING PAVEMENT SURFACE. THE REMAINING SIX INCHES (6") SHALL HAVE CONCRETE PLACED TO MATCH EXISTING ADJACENT PAVEMENT GRADE AND SHALL HAVE A GOOD, SMOOTH, NON-POLISHED RIDING SURFACE.
- 8. IN THE SPRING, WHEN ASPHALT PLANTS OPEN, THE CONCRETE AND STONE SHALL BE REMOVED TO THE EXISTING BOTTOM OF THE SUBBASE IN ORDER TO PERFORM FINAL RESTORATION PER PREVIOUSLY APPROVED N.Y.S.D.O.T. PAVEMENT RESTORATION PROCEDURES.

### TEST PITS

9. ALL TEST PITS IN THE PAVEMENT SHALL BE COMPLETED BY AN 18" SQUARE/ROUND VACUUM EXCAVATION.

#### **EXCAVATION SUPPORT SYSTEM REQUIREMENTS**

- 10. ANY EXCAVATION 5 FEET OR MORE IN DEPTH SHALL UTILIZE A SHIELDS AND SHORING OR SHEETING SYSTEM WHICH PROVIDES DIRECT CONTACT AND SUPPORT OF THE EXCAVATION SIDES. THE SYSTEM SHALL ACCOMMODATE ANY ASSOCIATED SURCHARGE LOADS AND SHALL BE SUBMITTED TO NYSDOT'S REGIONAL GEOTECHNICAL ENGINEER FOR REVIEW AND APPROVAL PRIOR TO PERMIT ISSUANCE.
- 11. A SLOPING (LAYBACK) OPTION WILL NOT BE ALLOWED.
- 12. SHIELDS AND SHORING OR SHEETING SYSTEM REQUIREMENTS DO NOT PERTAIN TO TEST PITS WHICH ARE 18" OR LESS IN DIAMETER.

#### WORK ZONE TRAFFIC CONTROL GENERAL NOTES

ACTIVITY AREA

- - THE TYPICAL DETAILS DEPICTED ON THE STANDARD SHEETS AND IN THE MUTCO, REFLECT THE MINIMUM REQUIREMENTS. 2. PROPOSED REVISIONS TO THE TRAFFIC CONTROL PLAN SHALL BE PROVIDED, IN WRITING, TO THE DOT ENGINEER FOR REVIEW AND APPROVAL BY THE REGIONAL DIRECTOR OR HIS/HER DESIGNEE FIVE (5) WORK DAYS PRIOR TO THE PLANNED IMPLEMENTATION OF SUCH PROPOSED REVISIONS, EXCEPT FOR CHANGES THAT ALTER THE SCOPE OF THE TRAFFIC CONTROL PLAN. SUCH CHANGES IN SCOPE MUST BE SUBMITTED TO THE ENGINEER FOR APPROVAL BY THE REGIONAL DIRECTOR OR HIS/HER DESIGNEE THIRTY (30) WORKING DAYS PRIOR TO IMPLEMENTATION OF SUCH REVISIONS.
- 3. THE NAMES, ADDRESSES, AND TELEPHONE NUMBERS OF STAFF WHO ARE AUTHORIZED TO SECURE LABOR, MATERIALS, AND EQUIPMENT FOR EMERGENCY REPAIRS OUTSIDE NORMAL WORKING HOURS SHALL BE PROVIDED, IN WRITING, TO THE DOT ENGINEER THE ENGINEER WILL PROVIDE THE SUBMITTED INFORMATION TO REGIONAL MANAGEMENT, THE NEW YORK STATE POLICE, THE RESIDENT ENGINEER, AND THE LOCAL POLICE.
- STANDARD SHEET 619-503 MAY BE USED FOR AN OFFSITE DETOUR SETUP FOR BOTH LONG TERM AND SHORT TERM WORK DURATIONS.
- 5. SEE EI 17-010 FOR MAJOR HOLIDAYS RESTRICTIONS.
- PLAN AHEAD TO AVOID CONFLICTING WORK ZONES, CHECK FOR CONSTRUCTION PROJECTS, CLOSURES, & RESTRICTIONS AT WWW.511NY.ORG, WWW.DOT.NY.GOV/PROJECTS, AND WITH DOT ENGINEER.
- 8. TRAVELER ADVISORY FORM & MATRIX MUST BE SUBMITTED PRIOR TO CLOSURE AS REQUIRED BY TSMI 19-04 FOR POLICE SERVICES. CALL REGIONAL TRAFFIC MANAGEMENT CENTER (TMC) ON DAY OF WORK BEFORE LANE CLOSURE SETUP AND WHEN LANE CLOSURE REMOVED.
- 11. CONSIDER CLOSURE WIDTH & CLEAR WIDTH FOR WIDE VEHICLES ON WIDE LOAD ROUTES. SEE HIGHWAY DESIGN MANUAL §16.4.4.3, CONSTRUCTION ADMINISTRATION MANUAL §104-08.IV., AND OVER-SIZE VEHICLE SCREENING TOOL (BRIDGE WIDTHS & 16" WIDE LOAD ROUTES). SUBMIT RESTRICTION NOTICE FORM HC 104 IF APPLICABLE.
- WHEN TWO OR MORE AREAS ARE ADJACENT, OVERLAP, OR ARE IN CLOSE PROXIMITY, THE CONTRACTOR SHALL ENSURE THERE ARE NO CONFLICTING SIGNS AND THAT LANE CONTINUITY IS MAINTAINED THROUGHOUT ALL WORK AREAS.

- SIGNS AT OR NEAR INTERSECTIONS SHALL BE PLACED SO THAT THEY DO NOT OBSTRUCT A MOTORIST'S LINE OF SIGHT.
- SIGNS MOUNTED ON THE MEDIAN OF DIVIDED HIGHWAYS WHERE MEDIAN BARRIER IS IN PLACE MAY BE MOUNTED ON THE BARRIER WITH A SADDLE TYPE BRACKET. LAYING THE SIGN DOWN IN A HORIZONTAL POSITION IS NOT PERMITTED. . THE DIMENSIONS OF WORK ZONE TRAFFIC CONTROL SIGNS ARE DESCRIBED IN THE MUTCD. ANY CHANGES TO THE DIMENSIONS SHALL BE APPROVED BY THE REGIONAL DIRECTOR OR BY HIS/HER DESIGNEE.
- NYR9-12 SHALL BE USED IN PLACE OF NYR9-11 WHEN A REDUCED REGULATORY SPEED LIMIT SIGN IS AUTHORIZED.

- WHERE POSSIBLE ALL CHANNELIZING AND GUIDING DEVICES ARE TO BE PLACED SO AS TO PROVIDE A MINIMUM 2' LATERAL CLEARANCE TO THE TRAVELED WAY.
- PROPERTY OWNERS WHOSE DRIVEWAYS WILL BE MADE INACCESSIBLE SHALL BE NOTIFIED AT LEAST 24 HOURS PRIOR TO RESTRICTING USE OF THE DRIVEWAY. FOR MULTIPLE ACCESS PROPERTIES, AT LEAST ONE DRIVEWAY SHALL BE OPEN AT ALL TIMES. ACCESS SHALL BE RESTORED TO ALL DRIVEWAYS AS SOON AS POSSIBLE.
- SUITABLE RAMPS SHALL BE INSTALLED TO MAINTAIN SMOOTH TRANSITIONS FROM RESIDENTIAL AND COMMERCIAL DRIVEWAYS TO AND FROM THE WORK AREA.
- NAME TIME USER

LANE CLOSURES

SPEED REDUCTION

PROTECTIVE VEHICLES

- LANE CLOSURES SHALL BE LOCATED TO PROVIDE OPTIMUM VISIBILITY, I.E. BEFORE CURVES AND CRESTS, TO THE EXTENT CONDITIONS PERMIT.
  - LANE WIDTHS
  - A WRITTEN NOTE SHALL BE PROVIDED TO THE ENGINEER, A MINIMUM OF 21 CALENDAR DAYS
    IN ADVANCE OF PERFORMING ANY WORK THAT RESULTS IN THE REDUCED WIDTH OF AN
    EXISTING ROADWAY, SO THAT THE ENGINEER MAY NOTIFY THE REGIONAL PERMIT ENGINEER
    IN A TIMELY MANNER.

1. SEE EI 08-030 & HDM §16.4.6. POSTED SPEED LIMITS IN NYS RIS VIEWER.

- 1. A PROTECTIVE VEHICLE IS A LARGE DUMP TRUCK, A LARGE RACK TRUCK OR OTHER VEHICLE HAVING A GROSS WEIGHT OF AT LEAST 24,000 POUNDS. IF THE PROTECTIVE VEHICLE ENCROACHES INTO THE TRAVEL LANE, OR IF IT REMAINS ENTIRELY ON THE SHOULDER OF ANY HIGH SPEED ROAD (45 MPH OR HIGHER), IT SHALL BE EQUIPPED WITH A DEPLOYED TRUCK/TRAILER MOUNTED IMPACT ATTENUATOR (TMIA, SEE TABLE 011-01 ON SHEET 619-11). PROTECTIVE VEHICLES MAY BE LOADED WITH SAND, GRAVEL, OR FINE AGGREGATE AS BALLAST TO ENHANCE THE VEHICLE'S GROSS WEIGHT. ANY BALLAST ADDED TO ENHANCE THE VEHICLE'S GROSS WEIGHT SHALL BE SECURED AS NOT TO BECOME DISLODGED IF IMPACTED.
- A PROTECTIVE VEHICLE USED IN A MOVING OPERATION IS REFERRED TO AS A SHADOW VEHICLE.
- A PROTECTIVE VEHICLE USED IN A STATIONARY OPERATION IS REFERRED TO AS A BARRIER VEHICLE.
- 4. IN A MOVING OPERATION OR A STATIONARY OPERATION THAT OCCUPIES A LOCATION FOR UP TO 1 HOUR, THE OPERATOR SHALL REMAIN IN THE PROTECTIVE VEHICLE WITH THE SAFETY BELT AND HEADREST PROPERLY ADJUSTED, MAINTAIN VEHICLE SPACING, AND KEEP THE WHEELS ALIGNED WITH THE LANE STRIPING, TWO-WAY RADIOS SHOULD BE USED TO COMMUNICATE BETWEEN THE OPERATOR AND THE WORK CREW.
- 5. IN A STATIONARY OPERATION THAT OCCUPIES A LOCATION FOR MORE THAN 1 HOUR, ONCE THE PROTECTIVE VEHICLE HAS BEEN APPROPRIATELY PLACED, IT SHOULD BE UNOCCUPIED. UNOCCUPIED VEHICLE SHALL BE POSITIONED PARALLEL TO TRAFFIC, PARKING BRAKE SET, PLACED IN 2ND GEAR (MANULAL TRANSMISSIONS / MENIEW OFF) OR PARK / NEUTRAL. (AUTOMATIC TRANSMISSIONS) AND HAVE THE FRONT WHEELS ALIGNED WITH THE LANE STRIPING AND LANE TO MAINTAIN LANE DISCIPLINE AND TO STAY IN LANE IF STRUCK.
- 6. WHEN A PROTECTIVE VEHICLE IS USED IN ADVANCE OF EITHER MOVING OR STATIONARY OPERATIONS TO DISPLAY SIGN MESSAGES, IT IS REFERRED TO AS AN ADVANCE WARNING VEHICLE. ADVANCED WARNING VEHICLES MAY BE OCCUPIED. UNICCUPIED. WHEN SIGNS ARE MOUNTED ON AN ADVANCED WARNING VEHICLE, THEY SHALL NOT DESTRUCT VISIBILITY OF ANY LIGHTS (TAILLIGHTS OR WARNING LIGHTS) OR SIDE-VIEW MIRRORS ON THE VEHICLE.
- NO WORK ACTIVITY, EQUIPMENT, VEHICLES AND/OR MATERIALS SHALL BE LOCATED BETWEEN THE PROTECTIVE VEHICLE AND THE ACTIVE WORK AREA GROLL AHEAD DISTANCE).
- PROTECTIVE VEHICLES MAY BE REQUIRED IN CONJUNCTION WITH POLICE PRESENCE IN THE WORK ZONE, TO BE INCLUDED IN THE UNIT BID PRICE FOR BASIC WORK ZONE TRAFFIC CONTROL, FOR CAPITOL CONSTRUCTION PROJECTS.
- WORK DURATION DEFINITIONS
  - A, LONG-TERM IS STATIONARY WORK THAT OCCUPIES A LOCATION MORE THAN 3 CONSECUTIVE DAYS.
  - B. INTERMEDIATE-TERM IS STATIONARY WORK THAT OCCUPIES A LOCATION MORE THAN ONE DAYLIGHT PERIOD UP TO 3 CONSECUTIVE DAYS, OR NIGHTTIME WORK LASTING MORE THAN 1 HOUR.
  - D. SHORT DURATION IS WORK THAT OCCUPIES A LOCATION UP TO 1 HOUR,

- A. STOP AND GO OPERATIONS WORK THAT COMPLETES WITHIN 5 MINUTES AND ALLOWS WORKERS ON FOOT.

ROADWAY TYPE DEFINITION

- FREEWAY: A. INTERSTATE: INTERREGIONAL HIGH-SPEED, HIGH-VOLUME, DIVIDED FACILITIES WITH COMPLETE CONTROL OF ACCESS.

#### ROADWAY TYPE DEFINITIONS (CONTINUED)

- 2. NON-FREEWAY: A. MULTILANE DIVIDED HIGHWAY
- B. MULTILANE UNDIVIDED HIGHWAY C. TWO-LANE TWO-WAY ROADWAY
- ALL NON-FREEWAYS CAN BE EITHER URBAN OR RURAL:
- URBAN: (MEETS MORE THAN 1 OF THE FOLLOWING CRITERIA)

  \*\*HIGH DENSITY DEVELOPMENT

  \*\*ON-STREET PARKING

  \*\*VARIED BUILDING SETBACKS

  \*\*MULTI-STORY AND LOW-TO MEDIUM-RISE STRUCTURES FOR RESIDENTIAL

  \*\*COMMERCIAL, AND EDUCATIONAL USES, STRUCTURES THAT ACCOMMODATE MIXED

  USES; COMMERCIAL, RESIDENTIAL, AND PARKING

  \*\*LIGHT INDUSTRIAL, AND SOMETIMES HEAVY INDUSTRIAL, LAND USE

  \*\*PROMINENT DESTINATIONS WITH SPECIALIZED STRUCTURES, E.G., LARGE THEATERS,

  SPORTS FACILITIES OR CONFERENCE CENTERS

  \*\*HIGH LEVELS OF PEDESTRIAN AND BICYCLIST ACTIVITY, WITH NEARLY CONTINUOUS

  SIDEWALKS AND MARKED CROSSWALKS

  \*\*HIGHER DENSITY OF TRANSIT STOPS AND ROUTES

  \*\*PRIVEWAY DENSITIES GREATER THAN 25 DRIVEWAYS/MILE ON EACH SIDE OF THE

  ROAD

  \*\*MUNDE COMMERCIAL DEPLYEMAN DENSITIES OF LO REDUCEWAYS/MILE ON EACH SIDE OF THE

  ROAD MAJOR COMMERCIAL DRIVEWAY DENSITIES OF 10 DRIVEWAYS/MILE OR GREATER
  MAJOR COMMERCIAL DRIVEWAYS
  HIGH DENSITY OF CROSS STREETS

RURAL: DOES NOT MEET MORE THAN ONE OF THE ABOVE CRITERIA.

- NOTES ON NIGHTTIME WORK: N1. WORK OCCURRING AFTER SUNSET AND BEFORE SUNRISE WILL BE CONSIDERED NIGHTTIME
- N3. ALL WORKERS INVOLVED SHALL WEAR PROTECTIVE HELMETS AND NIGHTTIME APPAREL IN ACCORDANCE WITH \$107-05A. HIGH VISIBILITY APPAREL AT ALL TIMES.
- NS. LEVEL I ILLUMINATION SHALL BE PROVIDED NEAR THE BEGINNING OF LANE CLOSURE TAPERS AND AT ROAD CLOSURES, INCLUDING THE SETUP AND REMOVAL OF THE CLOSURE
- NG. LEVEL II ILLUMINATION SHALL BE PROVIDED FOR FLAGGING STATIONS, ASPHALT PAVING MILLING, AND CONCRETE PLACEMENT AND/OR REMOVAL OPERATIONS, INCLUDING BRIDGE DECKS, 50 FEET AHEAD OF AND 100 FEET BEHIND A PAVING OR MILLING MACHINE.
- NT. LEVEL III ILLUMINATION SHALL BE PROVIDED FOR PAVEMENT OR STRUCTURAL CRACK FILLING, JOINT REPAIR, PAVEMENT PATCHING AND REPAIRS, INSTALLATION OF SIGNAL EQUIPMENT OR OTHER ELECTRICAL/MECHANICAL EQUIPMENT, AND OTHER TASKS INVOLVING FINE DETAILS OR INTRICATE PARTS AND EQUIPMENT.
- NB. ALL LIGHTING SHALL BE DESIGNED, INSTALLED, AND OPERATED TO AVOID GLARE THAT AFFECTS TRAFFIC ON THE ROADWAY OR THAT CAUSES ANNOYANCE OR DISCOMFORT FOR RESIDENCES ADJOINING THE ROADWAY.
- N9. PRIOR TO THE START OF NIGHTTIME OPERATIONS, A WRITTEN NIGHTTIME OPERATIONS AND LIGHTING PLAN IS REQUIRED FOR APPROVAL FROM THE OFFICE OF THE REGIONAL TRAFFIC FROM THE OFFICE OF THE REGIONAL TRAFFIC
- NIO. SEE NIGHTTIME SAFETY BULLETIN, HDM \$16.5.7, & STANDARD SPECIFICATIONS \$619 FOR ADDITIONAL REQUIREMENTS AND CONSIDERATIONS.

مر	NEW YORK STATE OF OPPORTUNITY.	Department of Transportation
	U.S. CUSTOMARY	STANDARD SHEET
W		AFFIC CONTROL NOTES

ISSUED UNDER EI 21-028

619-010

APPROVED DECEMBER 2, 2021

Robert Limoges ROBERT LIMOGES, P.E. DIRECTOR, OTSM

# TEMPORARY LANE / SHOULDER CLOSURE RESTRICTIONS FOR MAJOR HOLIDAYS

#### SPECIAL NOTE TEMPORARY LANE/SHOULDER CLOSURE RESTRICTIONS FOR MAJOR HOLIDAYS

There shall be no temporary lane/shoulder closures on roadway facilities owned and/or maintained by NYSDOT on the major holidays listed below.

Construction activities that will result in temporary lane/shoulder closures shall be suspended to minimize travel delays associated with road work for major holidays as follows:

Holiday	Falls on	Temporary lane closures are NOT allowed from
New Year's Day Independence Day	Sunday or Monday	6:00 AM Friday before to 6:00 AM Tuesday after
Christmas Day	Tuesday	6:00 AM Saturday before to 6:00 AM Wednesday after (starting at 6:00 AM Friday before to 6:00 AM Wednesday after for Christmas Day)
	Wednesday	6:00 AM Tuesday before to 6:00 AM Thursday after (starting at 6:00 AM Saturday before to 6:00 AM Thursday after for Christmas Day)
٠٠ - ١	Thursday	6:00 AM Thursday to 6:00 AM Monday after (starting at 6:00 AM Wednesday before to 6:00 AM Monday after for Christmas Day)
	Friday or Saturday	6:00 AM Thursday before to 6:00 AM Monday after

	AVAILUS CONTRACTOR OF THE PARTY	
Holiday	Falls on	Temporary lane closures are NOT allowed from
Memorial Day Labor Day	Monday	6:00 AM Friday before to 6:00 AM Tuesday after
Thanksgiving Day	Thursday	6:00 AM Wednesday before to 6:00 AM Monday after

#### Exceptions can only be made under the following conditions:


- Emergency work.
- Work within long-term stationary lane/shoulder closures.
- Safety work that does not adversely impact traffic mobility and has been authorized by the Regional Traffic Engineer.

Note: The Department reserves the right to cancel any work operations, including lane closures and/or total road closures, that would create traffic delays by unforeseen events. The Contractor would be notified at least seven (7) calendar days prior to the proposed work.

Powered by partnership

300 State Street, Suite 201 Rochester, NY 14614 585-454-6110


labellapc.com

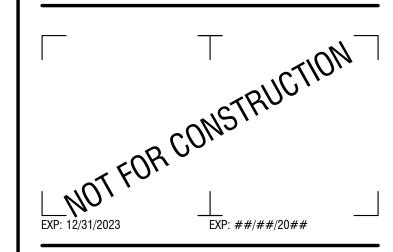

CERTIFICATE OF AUTHORIZATION NUMBER PROFESSIONAL ENGINEERING: 095099 LAND SURVEYING: 017976 GEOLOGICAL: 018750

It is a violation of New York Education Law Art. 145 Sec. 7209 & Art. 147 Sec. 7307, for any person, unless acting under the direction of a licensed architect, professional engineer, or land surveyor, to alter an item in any way. If an item bearing the seal of an architect, engineer, or land surveyor is altered; the altering architect, engineer, or land surveyor shall affix to the item their seal and notation "altered by" followed by their signature and date of such alteration, and a specific description of the alteration.

© 2023 LaBella Associates

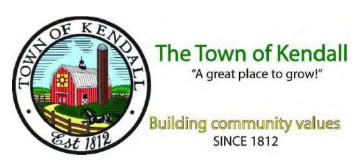

### REDI WASTEWATER **INFRASTRUCTURE** (CONTRACT 1)

TOWN OF KENDALL & TOWN OF HAMLIN

NO:	DATE:	DESCRIPTION:
Revisions		
PROJECT I	NUMBER:	2200455
DRAWN B	Y:	IOD
REVIEWED	BY:	JCB
		JRE
ISSUED FO	R:	

60% DESIGN SUBMISSION

SEPTEMBER 2023

**MPOT NOTES** 

DRAWING NUMBER:

DATE: